



Caring for Our Coast

♦ ♦ ♦  
**Gary Jones**  
Director

**Amy M. Caves**  
Chief Deputy Director






**Carol Baker**  
Deputy Director

**LaTayvius R. Alberty**  
Deputy Director

## MARINA DEL REY DESIGN CONTROL BOARD AGENDA

Wednesday, February 21, 2024, 1:30 p.m.

Burton W. Chace Park  
Community Building  
13650 Mindanao Way  
Marina del Rey, CA 90292

1.  **Call to Order, Land Acknowledgment, and Pledge of Allegiance**
2. **Approval of the October 18, 2023 Minutes**
3. **Consent Agenda**  
*The Chair may entertain a motion by a Board member at the beginning of the meeting to approve certain non-controversial agenda items as consent agenda items unless held by a Board member or member(s) of the public for discussion or separate action.*
4.  **Old Business**  
A. Parcel 28 – Wayfarer Apartments – DCB #23-009-B – Consideration of exterior repainting
5. **New Business**  
A. 2024 Design Control Board Meeting Schedule  
  
B. Parcel 44 – Pacific Ocean Management, LLC / South Coast Corinthian Yacht Club – DCB #24-001 – Consideration of new storage shed  
  
 C. Parcel 97 – Pacific Ocean Management, LLC / Marina Beach Shopping Center – DCB #24-002 – Consideration of new signage  
  
 D. Parcel UR – Marina del Rey Parking Lot 5 – DCB #24-003 – Consideration of electric vehicle charging stations
6.  **Staff Reports**  
A. Ongoing Activities Report
  - Board of Supervisors Actions on Items Relating to Marina del Rey
  - Regional Planning Commission's Calendar
  - Coastal Commission's Calendar
  - Future Major DCB Agenda Items
  - Small Craft Harbor Commission Minutes
  - Redevelopment Project Status Report  
B. Marina del Rey Special Events

C. DCB Annual Report

7. **Public Comment**

*This is the opportunity for members of the public to address the Board on items that are not on the posted agenda, provided that the subject matter is within the jurisdiction of the Board. Speakers are reminded of the three-minute time limitation.*

8. **Adjournment**

**PLEASE NOTE**

1. ADA ACCOMODATIONS: If you require reasonable accommodations or auxiliary aids and services such as material in alternate format or a sign language interpreter, please contact the ADA (Americans with Disabilities Act) Coordinator at (424) 526-7752 (Voice) or (TTY/TDD) users, please call the California Relay Service at 711. The ADA coordinator may be reached by email at [rstassi@bh.lacounty.gov](mailto:rstassi@bh.lacounty.gov).

2. The Los Angeles County Board of Supervisors adopted Chapter 2.160 of the Los Angeles Code (Ord. 93-0031 ~ 2 (part), 1993), relating to lobbyists. Any person who seeks support or endorsement from the Design Control Board on any official action must certify that he/she is familiar with the requirements of this ordinance. A copy of the ordinance can be provided prior to the meeting and certification is to be made before or at the meeting.

All materials provided to the Design Control Board Members are available for public review, beginning the Friday prior to the meeting, at the **four Marina del Rey locations listed below**. The Department of Beaches and Harbors website also provides all reports and audio files from current and past meetings. Electronic copies of project submittals for Business Items referred to in this agenda will be available online for a two week period from the date of this agenda.

Please visit the Department of Beaches and Harbors Website Address at <http://marinadelrey.lacounty.gov>, or the [Design Control Board Archive](#) for more information.

Department of Beaches and Harbors  
Administration Building  
13837 Fiji Way  
Marina del Rey, CA 90292

MdR Visitors & Information Center  
4701 Admiralty Way  
Marina del Rey, CA 90292

Burton Chace Park Community Room  
13650 Mindanao Way  
Marina del Rey, CA 90292

Lloyd Taber-Marina del Rey Library  
4533 Admiralty Way  
Marina del Rey, CA 90292

## **DESIGN CONTROL BOARD MINUTES**

### **October 18, 2023**

**Members Present:** Meg Rushing Coffee, Chair (First District); Genelle Brooks-Petty, Vice Chair (Second District); Harold Suetsugu, Member (Fifth District)

**Members Absent:** Steven Cho, Member (Fourth District)

**Department Staff Present:** LaTayvius Alberty, Deputy Director; Maral Tashjian, Planning Specialist; Porsche Nauls, Departmental Facilities Planner II; Tamika Simmons, Planner; Lola Reyna, Secretary

**County Staff Present:** Sevanna Hartonians, County Counsel

**Guests Testifying:** Jennifer Chung and Annie Tan, County of Los Angeles Department of Public Works (DPW); Wayne Espinoza, Tesla, Inc.; Wade Frazier and Cynthia Lee, PBWS Architects; Paul Lance

#### **1. Call to Order and Pledge of Allegiance**

Chair Coffee called the meeting to order at 1:35 pm.

Chair Coffee read the Land Acknowledgement and introduced the Pledge of Allegiance.

#### **2. Approval of the July 19, 2023 Minutes**

**Board Member Suetsugu moved to approve the July 19, 2023 minutes, seconded by Vice Chair Brooks-Petty.**

**Ayes: 3 – Chair Coffee, Vice Chair Brooks-Petty, Mr. Suetsugu**

**Nays: 0**

#### **3. Consent Agenda**

Board Member Suetsugu made the motion to move items 5A, 5B, and 5C to the consent agenda. Vice Chair Brooks-Petty moved to include item 5D on the consent agenda.

**Vice Chair Brooks-Petty moved that items 5A, 5B, 5C, and 5D be moved to the consent agenda, seconded by Board Member Suetsugu.**

**Ayes: 3 – Chair Coffee, Vice Chair Brooks-Petty, Mr. Suetsugu**

**Nays: 0**

#### **Public Comment**

Mr. Lance identified himself to the Board and requested to know what improvements were being made at Aubrey E. Austin Jr. Park. He was informed by staff that the project plans were available on the back table in the community room.

Ms. Chung, a Project Manager with DPW, introduced herself to the Board. She presented two promenade paver samples and expressed that the project team would like the Board to provide their opinion on the two color options for promenade pavers at the site.

Ms. Nauls clarified that the samples are related to the attempt of the project architects to match the promenade paver color with the neighboring project previously approved by the Board.

Ms. Alberty clarified that the Board did not need to remove the item from the consent agenda as approval could be granted to choose a similar material that matches the neighboring project.

**Vice Chair Brooks-Petty moved that items 3A, 3B, 3C, and 3D be approved, seconded by Board Member Suetsugu.**

**Ayes: 3 – Chair Coffee, Vice Chair Brooks-Petty, Mr. Suetsugu  
Nays: 0**

**4. Old Business**

A. Parcel 44 – Pacific Marina Venture, LLC / Tesla Motors, Inc. – DCB #22-011 – Consideration of Tesla supercharging station

Ms. Nauls presented the staff report.

Board Comment

Chair Coffee asked if there were any questions from the Board.

Mr. Suetsugu asked if any neighboring business had previously expressed any concerns about the addition of the charging stations.

Vice Chair Brooks-Petty clarified that this would be out of the Board's purview.

Ms. Nauls commented that the project has already been reviewed and approved by the Department of Regional Planning.

Chair Coffee asked if the chargers themselves would still be white and red.

Ms. Nauls confirmed that they would be.

Chair Coffee asked if there was a presentation from the applicant. Ms. Nauls stated there was no presentation but the applicant's design manager was available for questions. Chair Coffee asked that the applicant introduce himself for a question.

Mr. Espinoza, Design Manager for Tesla, introduced himself to the Board.

Chair Coffee asked if more than one pattern could be chosen for the vinyl wrap.

Mr. Espinoza confirmed that more than one option could be installed.

Mr. Suetsugu asked what kilowatt rating the chargers would be.

Mr. Espinoza stated that the chargers would be rated for 250 kilowatts.

Public Comment  
None

**Vice Chair Brooks-Petty moved to approve DCB #22-011 with vinyl wrap options 1 and 3, seconded by Board Member Suetsugu.**

**Ayes: 3 – Chair Coffee, Vice Chair Brooks-Petty, Mr. Suetsugu**  
**Nays: 0**

**5. New Business**

A. Parcel BB – Loyola Marymount University Bove Boathouse – DCB #23-007 – Consideration of exterior improvements and new signage

**Approved under consent agenda**

B. Parcel 44 – Pacific Marina Venture, LLC / Alfred Coffee – DCB #23-008 – Consideration of new signage and awning

**Approved under consent agenda**

C. Parcel 28 – Wayfarer Apartments – DCB #23-009 – Consideration of exterior repainting

**Approved under consent agenda**

D. Parcel BR – Aubrey E. Austin Jr. Park Renovation – DCB #23-010 – Consideration of site improvements

**Approved under consent agenda**

E. Parcel HS & 91 – Marina “Mother’s” Beach Restroom/Non-Motorized Boat Storage Renovation – DCB #23-011 – Conceptual design consideration of proposed site improvements

Ms. Simmons presented the staff report.

Board Comment

Chair Coffee asked if there were any questions from the Board.

Mr. Suetsugu commented that he liked the plan and its attention to the pedestrian experience. He inquired if staff would consider adding enhanced wayfinding signs and pedestrian lighting for increased safety and security.

Ms. Tashjian noted that the comment would be relayed to the project team for the final design review.

Chair Coffee inquired what the hours of operation would be for the structure.

Vice Chair Brooks-Petty inquired about the lockable hose bib and box finish.

Ms. Tan, a Project Manager with DPW, introduced herself. Ms. Tan stated that the hours of operation for the structure have not been established yet and the current restrooms hours are similar to those in other parks in the Marina. Final hours would be established by Department of Beaches and Harbors and take into consideration the new public gathering spaces proposed for the site. In addition, Ms. Tan stated that the hose bib would be a recessed component in a stainless steel box and explained that while the final finishes are still being selected, most of the finishes would be either anodized aluminum or stainless steel to withstand the marine environment.

Vice Chair Brooks-Petty asked if there would be lighting for the hours the structure is open.

Ms. Tan confirmed that lighting would be installed.

Chair Coffee asked if bathrooms could be made unisex for inclusivity.

Ms. Tan stated that the project may not be able to accommodate both the ADA bathrooms and unisex bathrooms, but DPW will review the potential for this change with the Department of Beaches and Harbors.

Chair Coffee asked if changing stations will be included.

Ms. Tan affirmed that there would be changing stations available.

Vice Chair Brooks-Petty noted that there could be potential to utilize the urinal space as a stall to accommodate a unisex bathroom as having inclusive restrooms is important for a public County facility.

#### Public Comment

None

**Chair Coffee moved to approve DCB #23-011 with conditions that the Board's recommendations regarding the bathroom layout be considered and all finishes and lighting shall be shown during the final design review. The motion was seconded by Vice Chair Brooks-Petty.**

**Ayes: 3 – Chair Coffee, Vice Chair Brooks-Petty, Mr. Suetsugu  
Nays: 0**

F. Parcel 49M – Marina del Rey Parking Structure – DCB #23-012 – Conceptual design consideration of proposed construction

Ms. Simmons presented the staff report.

#### Board Comment

Chair Coffee asked if there were any questions from the Board.

Mr. Suetsugu commented that the Board reviewed this project during a Board Briefing.

Ms. Tashjian clarified that the approval is for a conceptual review and the project would return for final design approval.

Ms. Jung, a Project Manager with DPW, and Mr. Wade Frazier of PBWS Architects introduced themselves to answer questions.

Chair Coffee asked about the sustainability of using real wood in terms of maintenance, graffiti, and vandalism. She also asked if the bioswale was connected to roof drainage, or if it is meant to be functional or decorative. If the bioswale would be functional, where would water flow and are there other storm water mitigation measures that would be implemented in the design. In addition, she commented that the plants selected seem to be high water users and non-native, particularly the trees, and she would like to see more California plants. Chair Coffee also commented on the use of real grass on the proposed mound and that this feature may be a maintenance and water issue. She also noted her preference for seeing other ground cover alternatives that are grass-like and more drought tolerant, with less maintenance requirements.

Mr. Frazier commented that he is working with DBH to select a stamped concrete pattern instead of actual wood material.

Chair Coffee asked for more information regarding benches proposed for the site.

Mr. Fraizer commented that the bench details have not been confirmed yet.

Chair Coffee noted that the benches included in the proposal appear to be very easy to use for skateboarding and comfortable to sleep on. She encouraged the project team to explore ways to discourage these activities.

Mr. Fraizer commented that stormwater treatment related to the proposed project would be connected to existing treatment efforts for the entire Parcel 49, including efforts near the Boat Launch Facility. The bioswale included in the project may be more decorative, but this would be confirmed once additional soil information is received.

Ms. Lee, a landscape architect for the project, commented that the plant palette would be drought tolerant with the exception of the trees. Trees would be deep watered with bubblers on a separate system. She noted that while the lawn area is small, it is an important piece of the design as it provides a space for seating and recreation.

Vice-Chair Petty Brooks noted the need for lighting to be placed at the crosswalk between the structure and Trader Joes. In addition, she asked if the seating near the mound would accommodate wheelchairs.

Mr. Fraizer confirmed that accessible seating would be included.

Vice-Chair Petty Brooks asked if a ride share area would be included.

Mr. Fraizer responded that opportunities for a rideshare area are being explored and would most likely use the street curb in front of the structure. He added that the site is relatively

narrow and the goal is to not encroach into boat launch area. In addition, he noted that there are lights along the bike path and agreed that there should be a lighting feature not only for bicycles but for pedestrian crossings. Mr. Frazier stated that there is a traffic study underway that would include related information.

Mr. Suestugu expressed interest in seeing the traffic study as he was concern about the stacking of cars and congestion when going in and out of the structure, as it would be a level structure with only one entrance.

Mr. Frazier noted that the intent of the structure would be for single entry for day to day activities and special events where the flow of the cars could be modified to pass through the boat launch parking lot.

Chair Coffee asked if there would be any accommodations for scooters?

Mr. Fraizer responded that scooters are not called out in design, but would be considered.

Chair Coffee commented that a bottle refilling station would be necessary if cyclists would pass through the area. She also noted that the design is still extremely busy and there is no focus. While she likes that the design reflects the marina and includes sails, there should be more cohesiveness in terms of shapes, colors, textures, and materials used.

Mr. Fraizer noted that the project team was reevaluating the design to be more simplified.

#### Public Comment

Mr. Lance addressed the Board and stated that the project would be adjacent to the Tesla project presented under Item 4A. He suggested that the projects be combined, moving the Tesla charging station into the proposed parking structure. He also noted that the two-story building would impact the view of the Marina. Mr. Lance also stated that he recognizes three hubs in the marina: Chace Park, Trader Joes, and the new Cedars Sinai building. He expressed that the parking lot does not provide access to any of those three areas.

**Chair Coffeee moved to approve DCB #23-012 with a condition that the recommendations regarding plant palette, design uniformity, sustainability, lighting, safety, accessibility, and multi-modes of mobility, including rideshares and scooters, be considered. The motion was seconded by Vice Chair Brooks-Petty.**

**Ayes: 3 – Chair Coffee, Vice Chair Brooks-Petty, Mr. Suetsugu  
Nays: 0**

#### **6. Staff Reports**

All reports were received and filed.

#### **7. Public Comment**

Mr. Lance addressed the Board and stated that he was a long-time resident in the Marina and had concerns with the opening of the Mariners Village Apartments promenade to the public, with the removal of the existing gates. He suggested that a gate be installed that would be provide controlled access to the promenade for safety reasons.

#### **8. Adjournment**

**Moved by Vice Chair Brooks-Petty, seconded by Board Member Suetsugu.**

**Ayes: 3 – Chair Coffee, Vice Chair Brooks-Petty, Mr. Suetsugu**

**Nays: 0**

**Chair Coffee adjourned the meeting at 3:08 p.m.**

Respectfully Submitted,

Lola Reyna  
Secretary for the Design Control Board



## Location of February 21, 2024 DCB Items



### Old Business

4A – Parcel 28 – Wayfarer Apartments

### New Business

5B – Parcel 44 – Boardwalk Marina del Rey / South Coast Corinthian Yacht Club

5C – Parcel 97 – Marina Beach Shopping Center

5D – Parcel UR – Parking Lot #5



Caring for Our Coast

♦ ♦ ♦

**Gary Jones**  
Director

**Amy M. Caves**  
Chief Deputy Director

**Carol Baker**  
Deputy Director

**LaTayvius R. Alberty**  
Deputy Director

February 21, 2024

TO: Design Control Board

FROM: Gary Jones, Director

**SUBJECT: ITEM 4A – PARCEL 28 – WAYFARER APARTMENTS – DCB #23-009-B  
CONSIDERATION OF EXTERIOR REPAINTING**

Item 4A on your agenda is a submittal from Wayfarer Apartments (Applicant), seeking approval for exterior repainting. The project is located at 14000 Palawan Way.

## **PROJECT OVERVIEW**

### Background

On October 18, 2023, your Board approved Wayfarer Apartments to repaint the exterior of the site with shades of blue, green, and off white. The Applicant has returned seeking approval to repaint the exterior of the site with a new color scheme.

### Existing Conditions

The project site is approximately 8.5 acres and is bordered by Del Rey Yacht Club to the east, public parking Lot #9 to the west, and the main channel to the north and south. The parcel is currently developed with a 379-unit residential community called Wayfarer Apartments, which consists of seven three-story residential buildings and a club house constructed over a two-level, semi-subterranean garage podium.

### Proposed Project

The Applicant proposes to repaint the exterior of the apartment buildings and club house, including all exterior wood and metal surfaces, doors, trims, siding, stucco, building walls, fencing, balconies, and gates.

## **BUILDING DESIGN**

### Exterior Colors

The Applicant proposes to repaint the exterior of the site with shades of blue, beige, and off white. All floors would be painted with Sherwin Williams colors. The Applicant proposes two color scheme options. Option 1, the Applicant's preference, would feature three colors. The first floor, roof edge, and balcony trims would be painted *Naval SW6244*, the second floor would be painted *Balanced Beige SW7037*, and the third and fourth



floors would be painted *Dover White SW6385*. Option 2 features two colors. The first floor, roof edge, and balcony trims would be painted *Naval SW6244*. The second, third, and fourth floor would be painted *Dover White SW6385*.

### **STAFF REVIEW**

Staff finds that the Applicant has selected a color palette that is representative of the Marina del Rey Design Guidelines Design Objective 1b, which encourages designs that complement the unique surrounding waterfront environment.

**Staff recommends APPROVAL of DCB #23-009-B, subject to the following conditions:**

- 1) No change shall be made to the approved design without written approval from the Department of Beaches and Harbors Planning Division staff.**
- 2) No substantial change shall be made to the approved design without the written consent of the Design Control Board.**

GJ:WO:ts



# WAYFARER®

Apartments + Marina

## MARINA MAP









Previously approved by the DCB on 10/18/2023



Sherwin Williams  
Dover White SW6385

Sherwin Williams  
Oceanside SW6496

Sherwin Williams  
Great Falls SW6495

Sherwin Williams  
Cloudburst SW6487

Sherwin Williams  
Aloe SW6464



Option 1 (Preferred)

Sherwin Williams  
SW 6385 Dover  
White

Sherwin Williams  
SW 7037 Balanced  
Beige

Sherwin Williams  
SW 6244 Naval



Option 2

Sherwin Williams  
SW 6385 Dover  
White

Sherwin Williams  
SW 6244 Naval





Caring for Our Coast

♦ ♦ ♦  
**Gary Jones**  
Director

**Amy M. Caves**  
Chief Deputy Director

**Carol Baker**  
Deputy Director

**LaTayvius R. Alberty**  
Deputy Director

February 21, 2024

TO: Design Control Board

FROM: Gary Jones, Director

**SUBJECT: ITEM 5A – DCB 2024 MEETING AND SUBMITTAL DEADLINES**

The filing deadline for any Design Control Board meeting submittal is noon, four Wednesdays prior to the date of the meeting. Design Control Board meetings begin at 1:30 p.m. on the third Wednesday of each month at the Burton Chace Park Community Building, 13650 Mindanao Way, Marina del Rey. Below are the 2024 meeting dates and filing deadlines.

<b>Meeting Date</b>	<b>Filing Deadline</b>
February 21, 2024	January 24, 2024
March 20, 2024	February 21, 2024
April 17, 2024	March 20, 2024
May 15, 2024	April 17, 2024
June 20, 2024*	May 22, 2024
July 17, 2024	June 19, 2024
August 21, 2024	July 24, 2024
September 18, 2024	August 21, 2024
October 16, 2024	September 18, 2024
November 20, 2024	October 23, 2024
December 18, 2024	November 20, 2024

\*The regularly scheduled meeting on Wednesday, June 19, 2024 would fall on a County holiday. Therefore, the Design Control Board meeting for June will be tentatively held on Thursday, June 20, 2024.





Caring for Our Coast

♦ ♦ ♦

**Gary Jones**  
Director

**Amy M. Caves**  
Chief Deputy Director

**Carol Baker**  
Deputy Director

**LaTayvius R. Alberty**  
Deputy Director

February 21, 2024

TO: Design Control Board

FROM: Gary Jones, Director

**SUBJECT: ITEM 5B – PARCEL 44 – PACIFIC OCEAN MANAGEMENT, LLC /  
SOUTH COAST CORINTHIAN YACHT CLUB – DCB #24-001 –  
CONSIDERATION OF NEW STORAGE SHED**

Item 5A on your agenda is a submittal from the South Coast Corinthian Yacht Club (Applicant) seeking approval for a new prefabricated storage shed. The project is located at 13444 Bali Way.

## **PROJECT OVERVIEW**

### Existing Conditions

Parcel 44 consists of approximately 8.39 landside acres and 4.68 waterside acres. The landside portion has frontages on Admiralty Way, Mindanao Way, Bali Way and Basin G. Parcel 44 is developed as the “Boardwalk Marina del Rey” shopping center, which consists of eight buildings with a total area of 82,652 square feet. The site includes Marine Commercial, Boat Storage, and Visitor-Serving/Convenience Commercial uses, in addition to two outdoor plazas with tiered stadium seating, waterfront views, an anchorage, and outdoor dining. South Coast Corinthian Yacht Club is located within Building VIII, along Bali Way, adjacent to a boat storage yard.

### Proposed Project

The Applicant proposes to install a new storage shed at the site. The shed would be used to store race equipment (anchors, buoys, flags, etc.) and other items for the boat yard and yacht club.

## **PROPOSED PROJECT**

The Applicant is seeking approval to replace an existing 7’ wide by 7’ long by 7’ tall, prefabricated storage shed, located within perimeter fencing to the west of a restroom building, adjacent to the public promenade. The new shed would be placed in the same location and would measure 8’ wide by 15’ long, with a height of approximately 7’. The shed exterior would consist of *Hat Box* brown colored engineered wood siding, *Ground Coffee* brown colored trims, and *Golden Cedar* colored roof shingles to complement the colors of the adjacent buildings. No exterior lighting is proposed for the storage shed.



**STAFF REVIEW**

Staff finds that the storage shed is generally consistent with the Marina del Rey Design Guidelines. The structure would be visible from the public promenade. Staff finds that the structure would not significantly impact any public views of Basin G as it would be placed within an existing boat storage facility (DG. 205). The proposed project does not require architectural modifications to the existing yacht club facility.

**Staff recommends APPROVAL of DCB #24-001, subject to the following conditions:**


- 1) The Applicant shall obtain approval from the Department of Regional Planning.**
- 2) No change shall be made to the approved design without written approval from the Department of Beaches and Harbors Planning Division staff.**
- 3) No substantial change shall be made to the approved design without the written consent of the Design Control Board.**

GJ:WO:ts

# Proposed Project




We are looking to upgrade the storage shed we have in the boatyard. We currently have a 7'x7' shed which we use to store our race equipment (anchors, buoys, flags, etc.) and other items for the boatyard and the club. With the growth of our racing program, we are finding that we need some additional outdoor storage space for these items and would like to install a Tuff Shed. The existing shed is a Rubbermaid product from Home Depot which works ok but what we are proposing would be a much nicer product (better finishes visually, but also functionally much sturdier). The proposed project would replace the existing shed with the newer one.

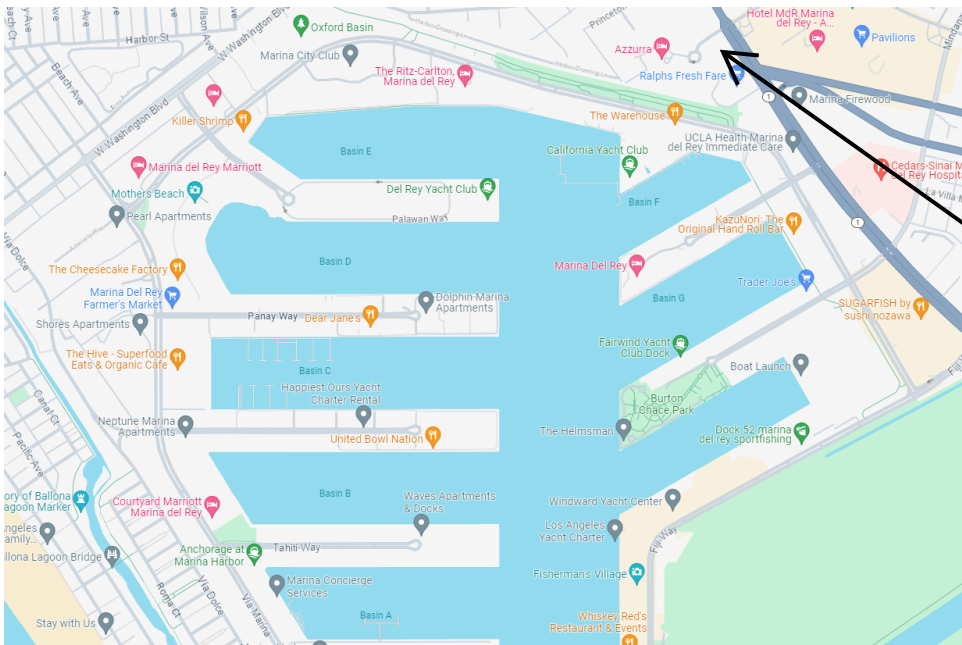

SCCYC

## Project Location

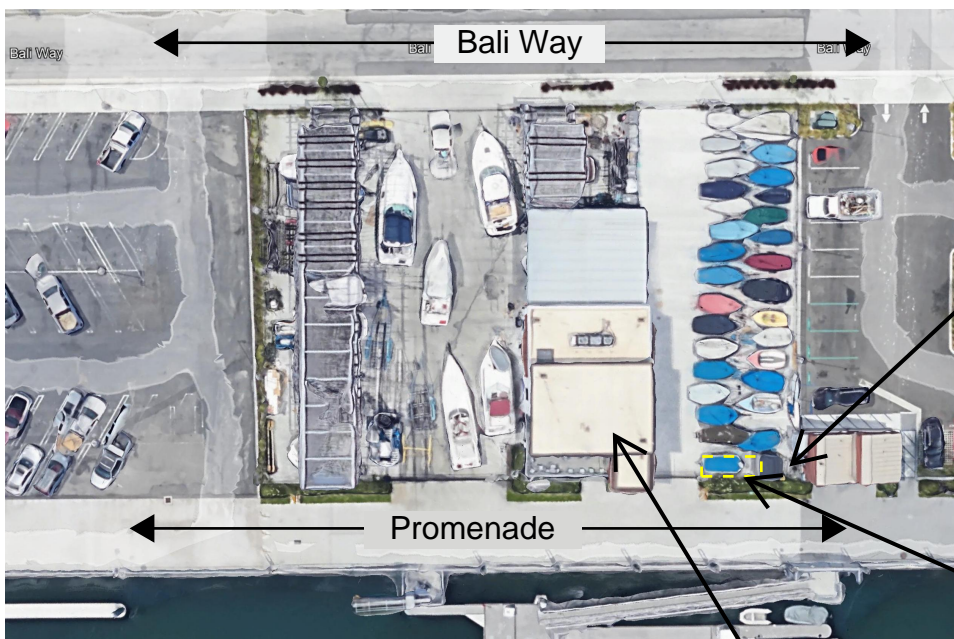


EXISTING SHED



PROPOSED SHED (YELLOW)

SCCYC

## Site Plan

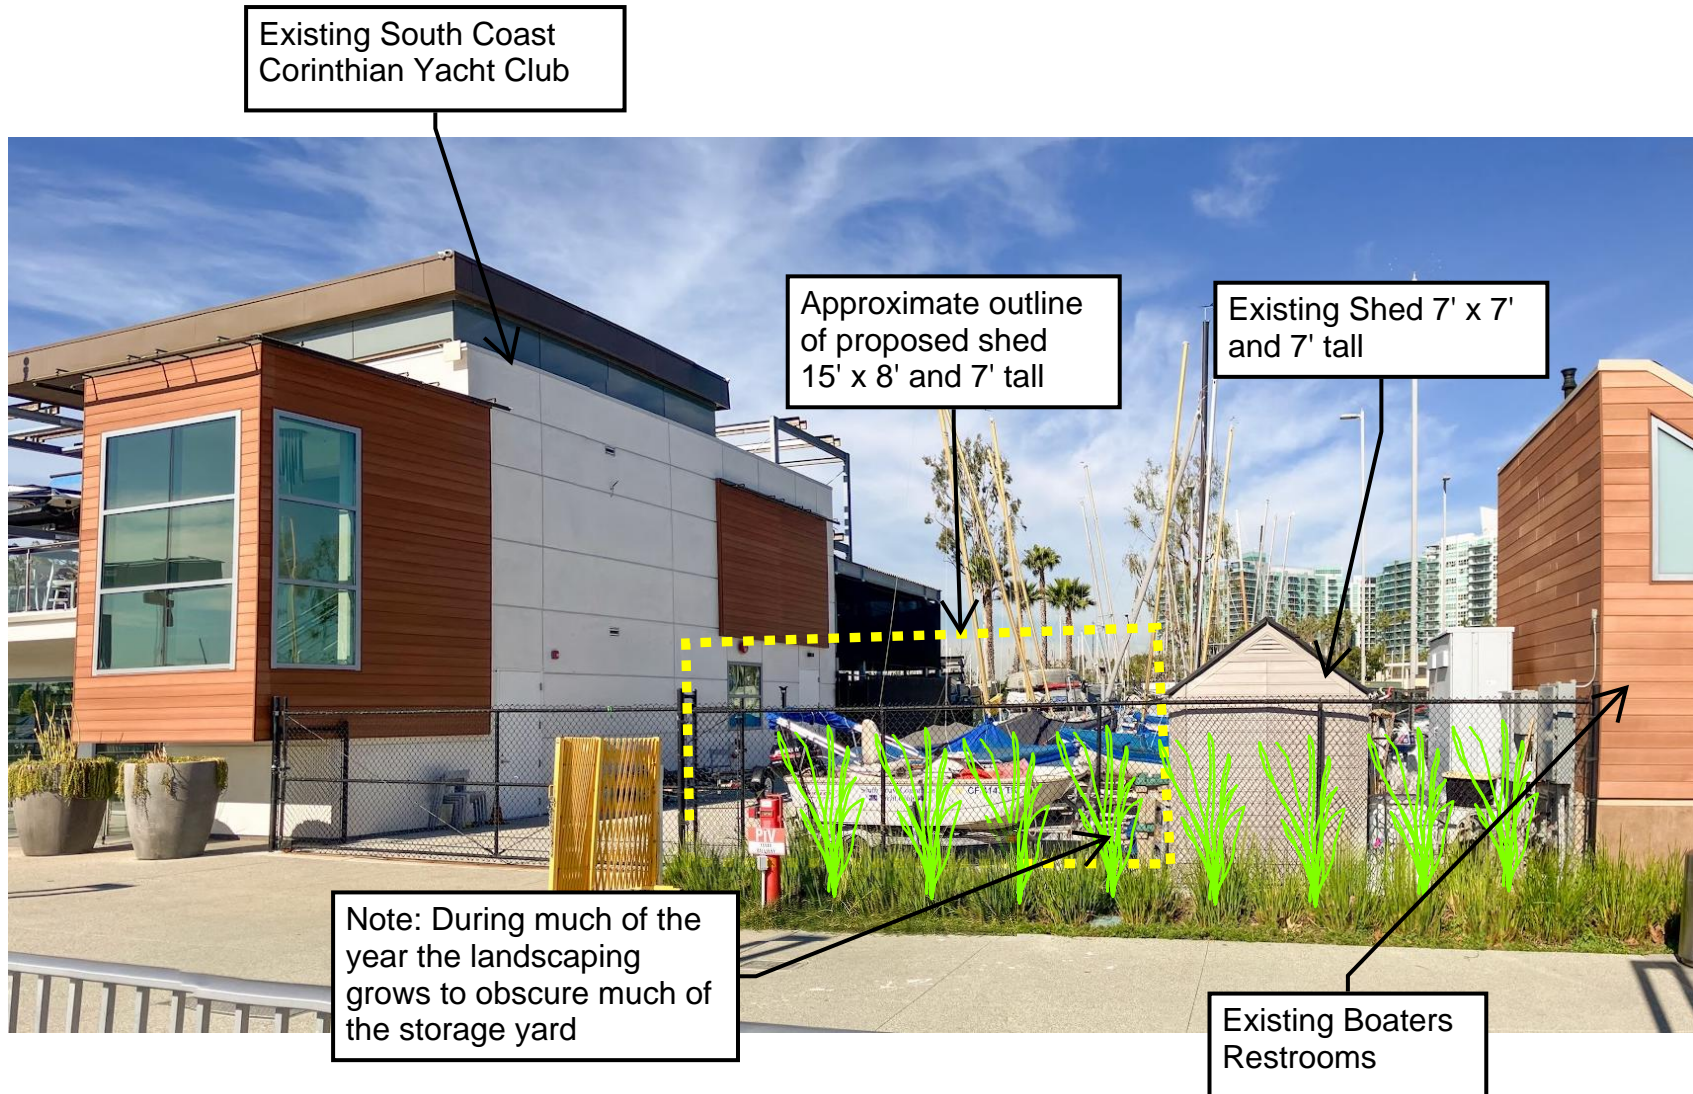


View from promenade

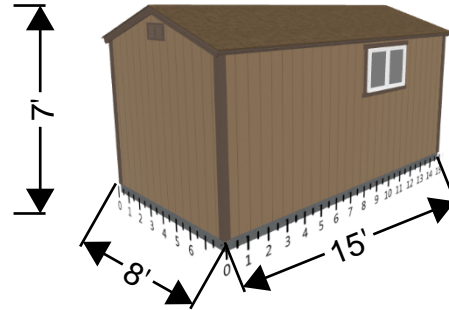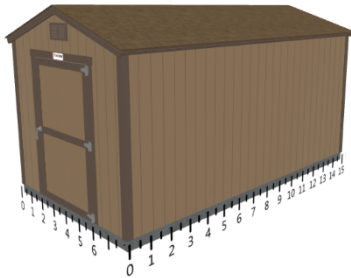

Wall D

Wall A

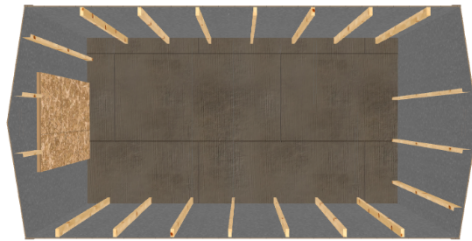

Wall C

Wall B

### **Base Details/Permit Details**

#### **Building Size & Style**

Premier Ranch - 8' wide by 15' long

#### **Door**

4' x 6'2" Single Shed Door, Right Hinge Placement

#### **Paint Selection**

Base: Hat Box Brown, Trim: Ground Coffee

#### **Roof Selection**

Golden Cedar 3 Tab

#### **Drip Edge**

Brown

#### **Is a permit required for this job?**

No, If local jurisdiction requires a permit, fees will be added before installation can take place

### **Optional Details**

#### **Windows**

3'x2' Insulated Horizontal Sliding Window

#### **Floor and Foundation**

4 Ea Shed Anchor into Dirt - Auger or MR88

#### **Vents**

2 Ea 16"x8" Wall Vent - Brown

### **Jobsite/Installer Details**

**Do you plan to insulate this building after Tuff Shed installs it?**

No

**Is there a power outlet within 100 feet of installation location?**

Yes

**The building location must be level to properly install the building. How level is the install location?**

Within 4" of level

**Will there be 18" of unobstructed workspace around the perimeter of all four walls?**

No

**Can the installers park their pickup truck & trailer within approximately 200' of your installation site?**

Yes

**Substrate Shed will be installed on?**

Anchored to Concrete with Shed Floor

Customer Signature: \_\_\_\_\_ Date: \_\_\_\_\_

## Proposed Finishes

Colors for the proposed shed are intended to complement the adjacent boater's restroom:

Golden Cedar for the roof

Hat Box Brown PPG 1095-6 for the field

Dark Coffee PPG 1076-7 for the trim



Golden Cedar



Hat Box Brown  
PPG 1085-6



Ground Coffee  
PPG 1076-7



Caring for Our Coast

♦ ♦ ♦  
**Gary Jones**  
Director

**Amy M. Caves**  
Chief Deputy Director

**Carol Baker**  
Deputy Director

**LaTayvius R. Alberty**  
Deputy Director

February 21, 2024

TO: Design Control Board

FROM: Gary Jones, Director

**SUBJECT: ITEM 5C – PARCEL 97 – PACIFIC OCEAN MANAGEMENT, LLC /  
MARINA BEACH SHOPPING CENTER – DCB #24-002 –  
CONSIDERATION OF NEW SIGNAGE**

Item 5C on your agenda is a submittal from Pacific Ocean Management, LLC (Applicant), seeking approval for new signage at the Marina Beach Shopping Center. The project is located at 510 Washington Boulevard.

## **PROJECT OVERVIEW**

### Background

On December 13, 2018, your Board approved a final renovation design and master sign program for the Marina Beach Shopping Center, with several conditions, including a requirement to return to your Board for review of tenant signs.

### Existing Conditions

The 1.8-acre Marina Beach Shopping Center is located on Washington Boulevard, between Via Marina and Palawan Way. The center consists of seven single story commercial buildings with a surface parking lot fronting Washington Boulevard and alley access with parking in the rear. A site renovation is currently underway. Sirian Massage is located in Building 1, The Cleaning Baron is located in Building 3, and Wolf's Liquor and Samoa's are located in Building 6.

### Proposed Project

The Applicant proposes to install four tenant identification signs.

## **SIGNAGE**

### Building Façade

The Applicant proposes to install four wall-mounted tenant identification signs facing Washington Boulevard above the main entrance of each tenant space. All signs would be installed approximately 12' above grade.

***Sirian Massage***

The blue and white colored, aluminum, reverse lit channel letter sign would measure 1'-8" tall by 14'-1" wide and read "Sirian Massage".

***Cleaning Baron***

The turquoise colored, aluminum, reverse lit channel letter sign that would measure 2'-3" tall by 35' wide and read "The Cleaning Baron" with a company logo.

***Sampas Pizza***

The reverse lit sign would feature white channel and push through lettering on a black circular background. The sign would measure approximately 6'-3" tall by 6'-3" wide and read "Pizza Café Sampa's Marina del Rey".

***Wolf's Liquor***

The turquoise colored, aluminum reverse lit channel letter sign would read "Wolf's Liquor" and measure approximately 2' tall by 19'-8" wide.

**Hours of Illumination**


The hours of illumination for all signs would be from dusk until dawn.

**STAFF REVIEW**

Staff finds the proposed project is generally consistent with the Marina del Rey Design Guidelines, and the Marina Beach Shopping Center Sign Program. Following DCB approval, all signs are subject to review by the Los Angeles County Department of Regional Planning for conformity with the Marina del Rey Revised Permanent Sign Controls.

**Staff recommends APPROVAL of DCB #24-002, subject to the following conditions:**

- 1) The Applicant shall obtain approval from the Department of Regional Planning.**
- 2) No change shall be made to the approved design without written approval from the Department of Beaches and Harbors Planning Division staff.**
- 3) No substantial change shall be made to the approved design without the written consent of the Design Control Board.**

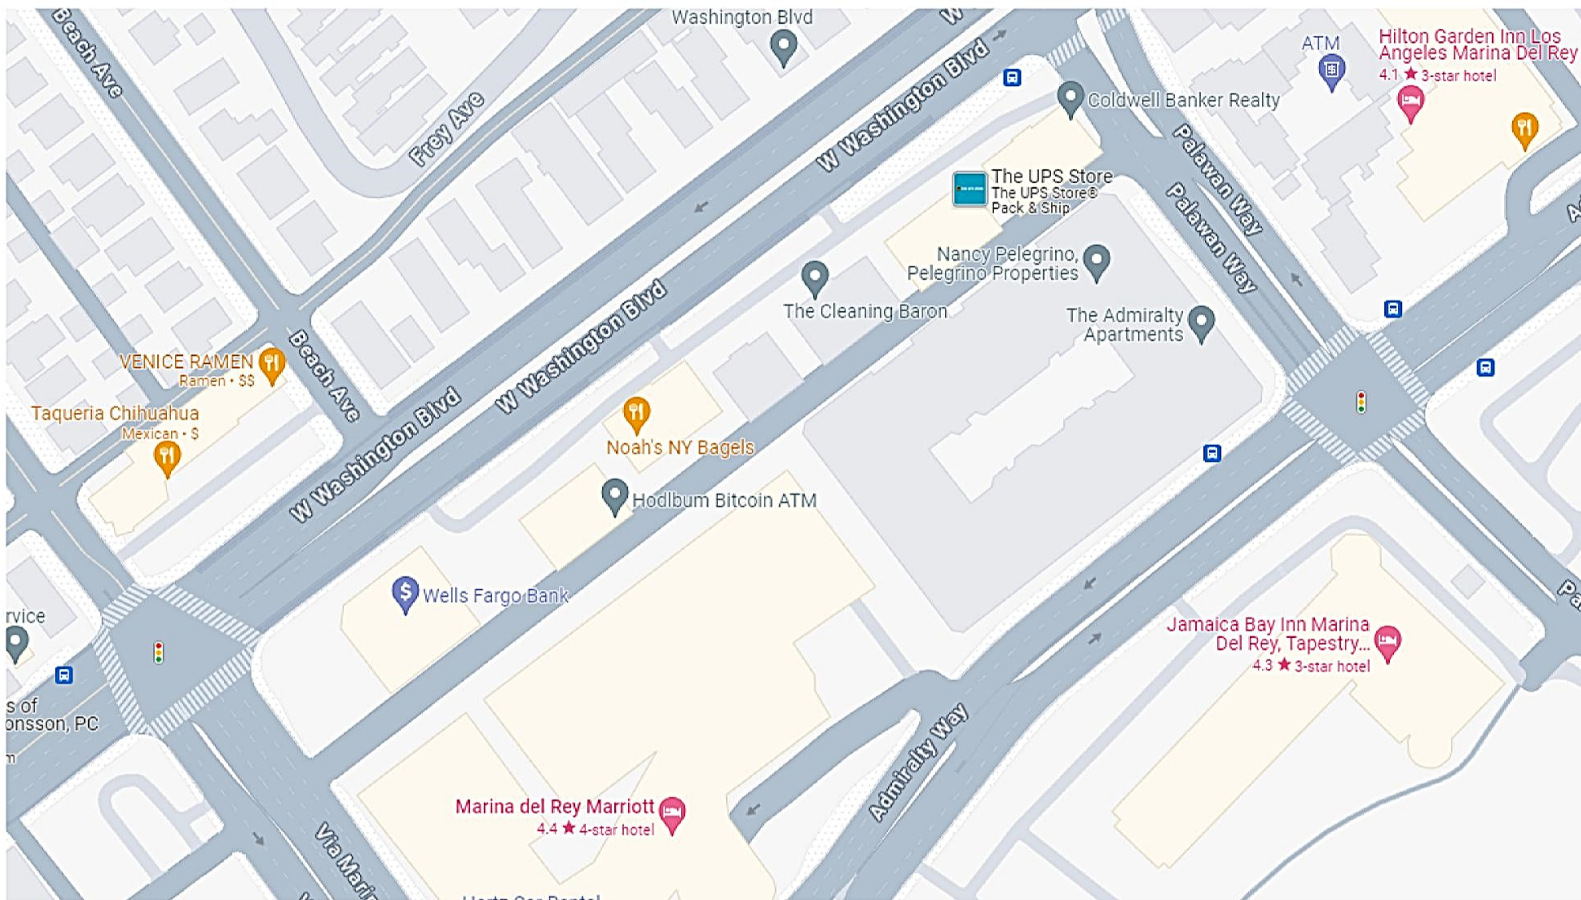

Continental Neon & Plastic Signs Inc.  
 14839 Clavert st, Van Nuys, CA 91411  
 Email :info@localsignco.com  
 Tel : 818- 785-1210  
 Fax : 818-909-4869  
 www.localsignco.com

Project:

Job Address:


Salesperson:

Kevin Kosar 818- 785-1210

Date:

Drawn By:

Customer Approval:

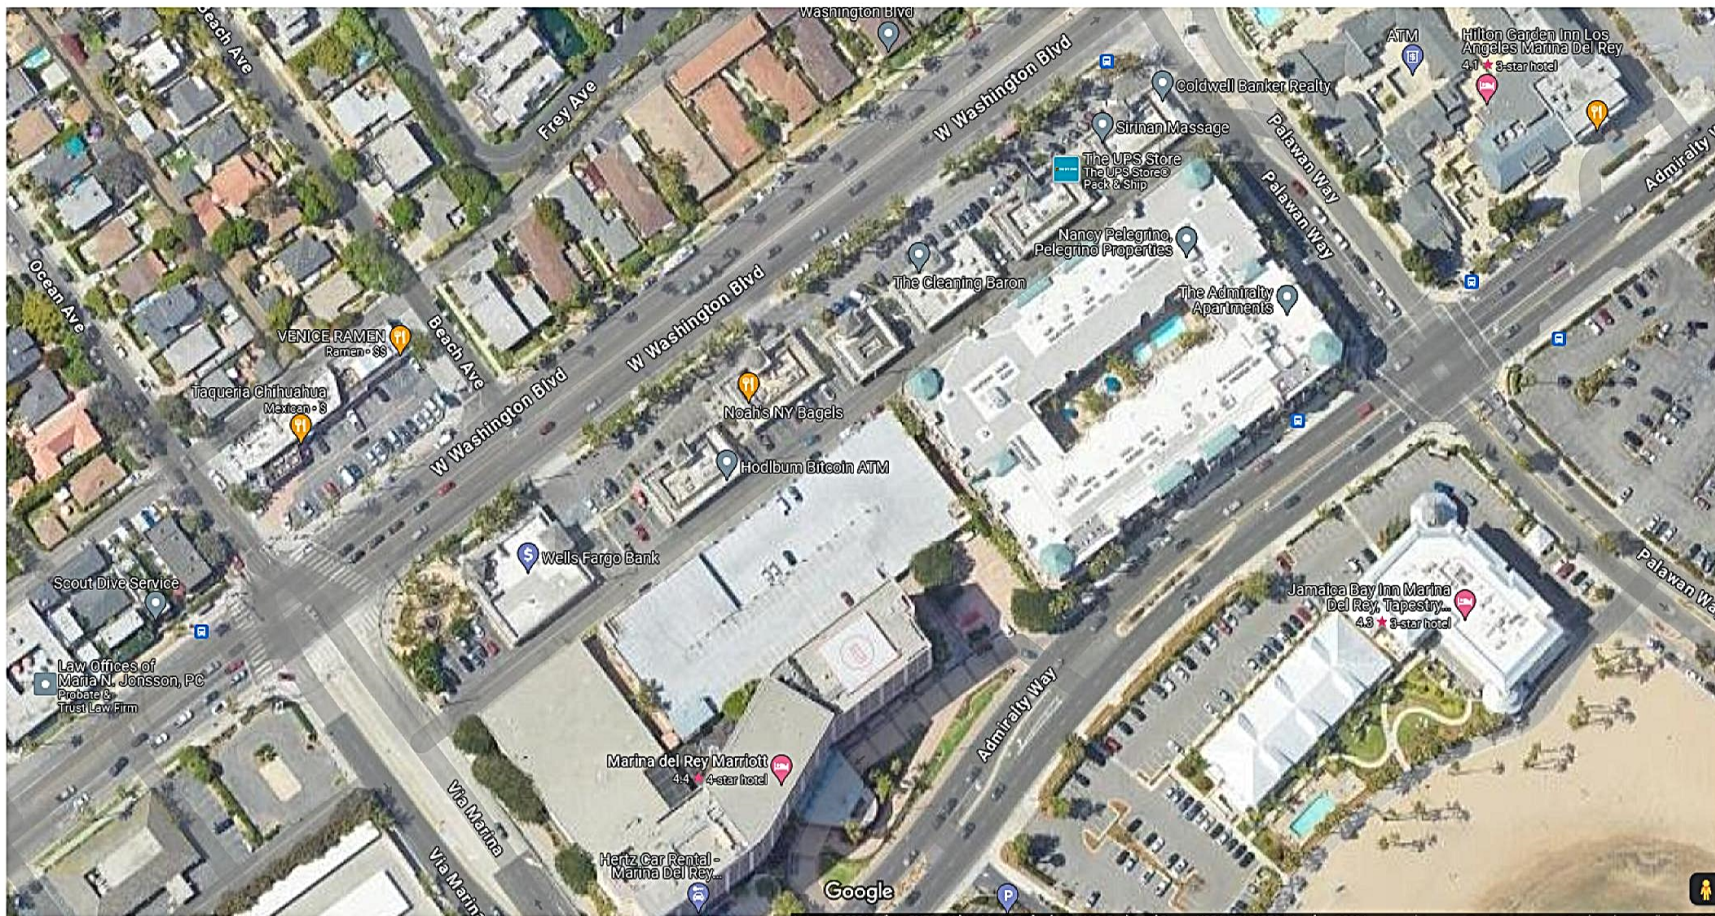

Quality **SIGNS** of all kinds  
**818-7851210**

Continental Neon & Plastic Signs Inc.  
 14839 Clavert st, Van Nuys, CA 91411  
 Email :info@localsignco.com  
 Tel : 818- 785-1210  
 Fax : 818-909-4869  
 www.localsignco.com

Project:

Job Address:

Salesperson:


Kevin Kosar 818- 785-1210

Date:

Drawn By:

Customer Approval:

PALAWAN WAY  
(80' WIDE PRIVATE RIGHT OF WAY)

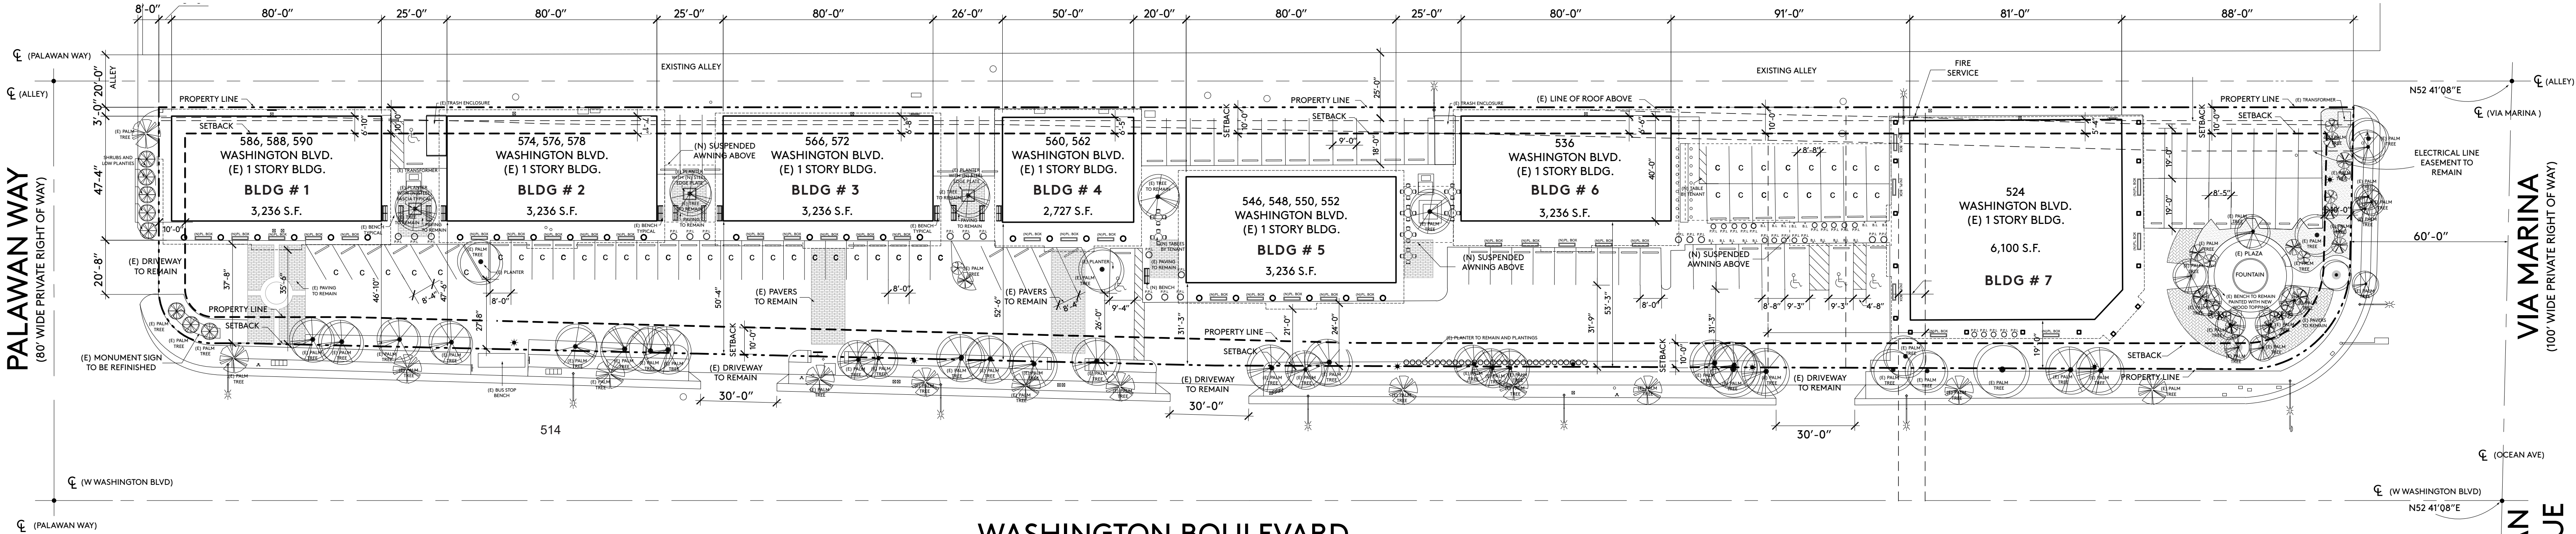


WASHINGTON BOULEVARD  
(VARIABLE WIDTH PUBLICLY DEDICATED RIGHT OF WAY)

VIA MARINA  
(100' WIDE PRIVATE RIGHT OF WAY)

OCEAN AVENUE



586 Washington Blvd

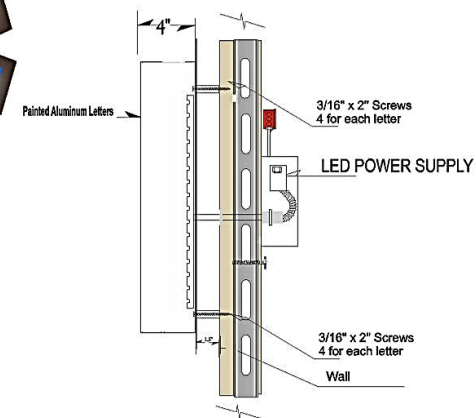

Connection to the wall directly

- . Material: Aluminum
- . Color: Blue
- . Type: Reverse Channel letters
- . Copy: Sirian Massage
- . Font: Ming Liu
- . Size: 20" x 170"
- . Total Allowable: 26 Sf.
- . Illumination: White LED

Total Allowable : 26 Sq.



Continental Neon & Plastic Signs Inc,  
14839 Calvert St. Van Nuys CA 91411

Email: [info@localsignco.com](mailto:info@localsignco.com)

Tel: 818- 785-1210

[www.localsignco.com](http://www.localsignco.com)

Project :

Job Address:  
586 Washington Blvd.


Date:

Drawn By:


Customer Approval:

Page #:


S-3

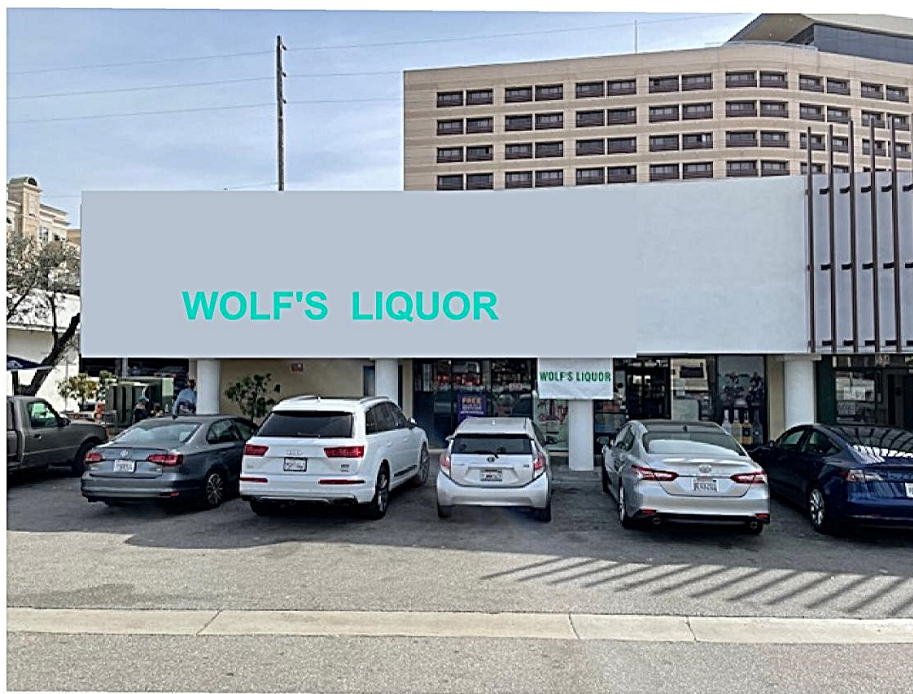

**SIGN 11** 536 Washington Blvd

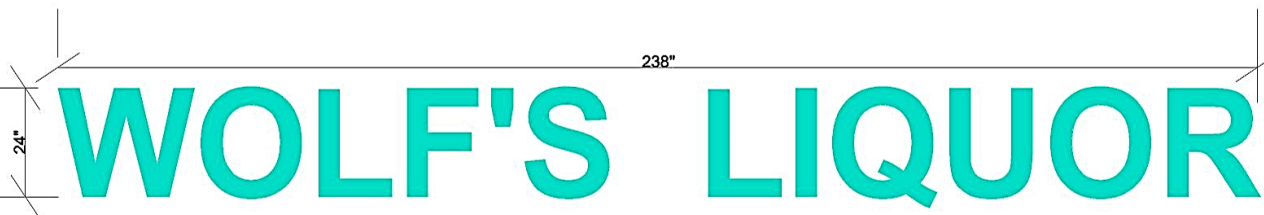

- . Material: Aluminum
- . Color: Turquoise
- . Type: Reverse Channel letters
- . Copy: Wolf's Liquor
- . Font: Arial Bold
- . Size: 24" x 238"
- . Total Allowable: 40 Sf.
- . Illumination: White LED

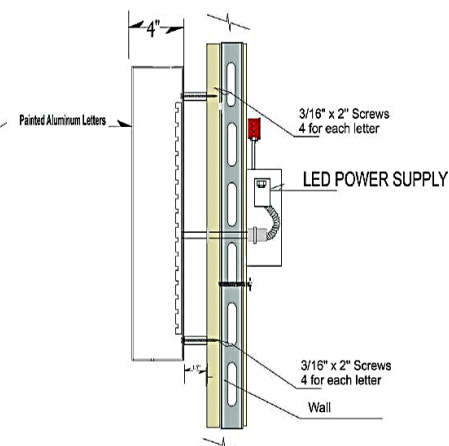

## Connection to The Wall

Total Allowable : 40 Sf.



Continental Neon & Plastic Signs Inc.  
14839 Clavert st, Van Nuys, CA 91411  
Email :info@localsignco.com  
Tel : 818- 785-1210  
Fax : 818-909-4869  
www.localsignco.com

Project:

Job Address:

Salesperson:

Kevin Kosar 818- 785-1210

Date:

Drawn By:

Customer Approval:




420"

THE CLEANING BARON

27"

## Project Description:

- . Material: Aluminum
- . Color: Turquoise
- . Type: Reverse Channel letters
- . Copy: Cleaning Baron
- . Font: Baskerville
- . Size: 27" x 420"
- . Total Allowable: 80 Sf.
- . Illumination: White LED

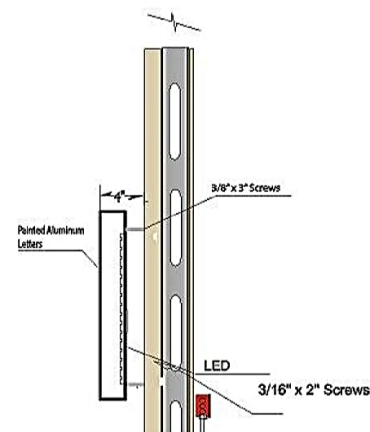

Connection To The Wall



Continental Neon & Plastic Signs Inc.  
14839 Clavert st, Van Nuys, CA 91411  
Email :info@localsignco.com  
Tel : 818- 785-1210  
Fax : 818-909-4869  
www.localsignco.com

Project:

Job Address:

566 W. Washington Blvd.

Salesperson:

Kevin Kosar 818- 785-1210


Date:

Drawn By:

Customer Approval:



- . Material: Aluminum
- . Color: White
- . Type: Reverse Channel letters  
And Push through Letters
- . Copy: Sampa's Pizza Cafe- Marina Del Ray
- . Font: N/a
- . Size: 76" x 76"
- . Total Allowable: 40 Sf.
- . Illumination: White LED

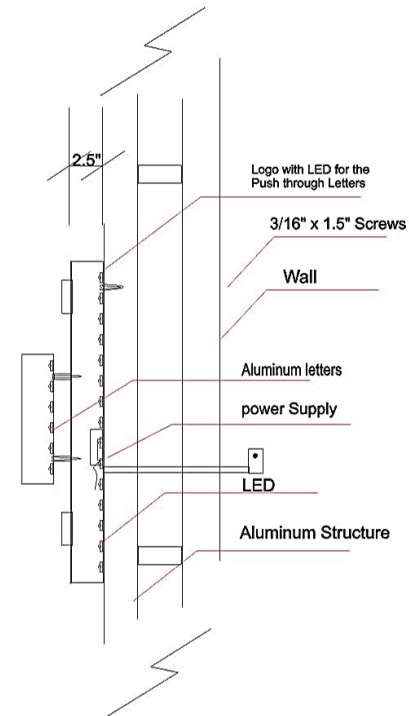

Connection To the Wall



Continental Neon & Plastic Signs Inc.  
14839 Clavert st, Van Nuys, CA 91411  
Email :info@localsignco.com  
Tel : 818- 785-1210  
Fax : 818-909-4869  
www.localsignco.com

Project:

Job Address:

534 Washington Blvd

Salesperson:

Kevin Kosar 818- 785-1210

Date:

Drawn By:

Customer Approval:

S12



Caring for Our Coast

♦ ♦ ♦  
**Gary Jones**  
Director

**Amy M. Caves**  
Chief Deputy Director

**Carol Baker**  
Deputy Director

**LaTayvius R. Alberty**  
Deputy Director

February 21, 2024

TO: Design Control Board

FROM: Gary Jones, Director

**SUBJECT: ITEM 5D – PARCEL UR – COUNTY OF LOS ANGELES INTERNAL SERVICES DEPARTMENT – DCB # 24-003 – CONSIDERATION OF ELECTRIC VEHICLE CHARGING STATIONS**

Item 5D on your agenda is a submittal from the County of Los Angeles Internal Services Department (Applicant), seeking approval for electric vehicle charging stations and associated improvements at Marina del Rey Parking Lot 5. The project is located at 4554 Admiralty Way.

## PROJECT OVERVIEW

### Background

The County of Los Angeles (County) aims to be at the forefront of promoting electric vehicle (EV) adoption and contributing to the expansion of charging infrastructure throughout the region. Transitioning from internal combustion engines to battery electric, plug-in hybrids, and other clean options is critical for improving air quality and reducing greenhouse gas emissions from vehicles in California. The Board of Supervisors adopted the County Sustainability Plan in August 2019 which directs the County to install 5,000 EV charging stations by 2025 and 15,000 charging stations by 2035. The Plan also directs the County to have 100% of new non-emergency light-duty vehicle purchases be zero-emissions by 2025 and 100% of medium-duty vehicles and emergency light-duty vehicle purchases be zero-emissions by 2035. By 2045, 100% of all vehicles in the County fleet are expected to be zero-emissions. Having electric vehicle supply equipment in place throughout the County is pivotal to this transition.

### Existing Conditions

The property is an existing surface parking lot with 221 parking spaces.

### Proposed Project



The Applicant proposes to install forty electric vehicle charging stations and associated equipment in Marina del Rey Parking Lot 5.

## **SITE DESIGN**

### Electric Vehicle Chargers

The Applicant proposes to install an electric vehicle charging station system consisting of forty charging posts, two distribution boards, one load management controller, two utility transformers, a panel board, and a meter cabinet, which would be installed in various areas along Admiralty Way and Bali Way. Each charging posts would be approximately 5' wide by 6' tall.

Distribution equipment associated with the charging stations would be located on a concrete pad along Bali Way. Each distribution panel would be 5'-2" tall by 1'-8" wide, with a depth of 6.5" and the panel board/meter cabinet would measure 3'-2" wide by 4'-6" tall, with a depth of 11". The main utility transformer would be 5'-2" wide by 5'-1" tall, with a depth of 5'-11", while the step-down transformer would measure 3' wide by 3'-4" tall, with a depth of 1'-10". Yellow colored 4' tall steel concrete barrier bollards would be installed around the equipment.

To accommodate American Disability Act (ADA) electric vehicle parking spaces and associated improvements, one existing parking space would be removed. The Applicant proposes to install an accessible loading zone adjacent to the ADA parking stalls, that would include 4" wide diagonal striping with "no parking" painted on the ground. A new accessible walkway/ramp would connect the ADA electric vehicle parking space to the sidewalk along Admiralty Way.

### Screening

The Applicant would place a camouflage vinyl wrap on the distribution boards, panel board, meter cabinet, and transformers. The proposed art wrap design would incorporate a scenic view within Marina del Rey, which is consistent with DG. 21 as it would incorporate nautical, marina, and/or water themes to complement the Marina's waterfront setting.

### Landscaping

To accommodate the project, ground cover and shrubs located along Admiralty Way would be removed as the charging posts and other improvements would be installed in the current planter area. Landscaping to match the existing plant palette at the site would be reintroduced in empty spaces once the charging stations are installed. No trees would be removed.

## **STAFF REVIEW**

Staff finds that the proposed project is generally consistent with the Marina del Rey Design Guidelines (DG). DG. 188 notes that projects should screen and buffer antennas and on-site transformers from any public street views. While the equipment proposed

along Bali Way would be visible from street view, the equipment would be screened with a camouflage art wrap that incorporates nautical, marina, and/or water themes to complement the Marina's waterfront setting and reduce the visual impact of the equipment (DG. 21).

**Staff recommends APPROVAL of DCB #24-003, subject to the following conditions:**

- 1) No change shall be made to the approved design without written approval from the Department of Beaches and Harbors Planning Division staff.**
- 2) No substantial change shall be made to the approved design without the written consent of the Design Control Board.**

GJ:WO:ts



0 78 156 Feet

## Marina del Rey Parking Lot #5

### Vicinity Map

Printed: 2/14/24



Disclaimer: This map represents a quick representation of spatial imagery or vector layers using GIS-NET. The map should be interpreted in accordance with the GIS-NET Public disclaimer statement. Printed with permission from the Los Angeles County Dept. of Regional Planning. All rights reserved.



## EXISTING SITE CONDITIONS



## EXISTING SITE CONDITIONS





ELECTRIC VEHICLE CHARGING STATION (EVCS)

MARINA DEL REY LOT 5  
4545 ADMIRALTY WAY  
MARINA DEL REY, CA 90292  
APN: 4224-007-903

DEVELOPER:

powerflex  
EDF renewables

392 FIRST STREET  
LOS ALTOS, CA 94022  
P: 650.469.3392



ELECTRICAL ENGINEER:

nazarene engineering

NAZARENE ENGINEERING  
2514 JAMACHA RD. #502-182  
EL CAJON, CA 92019  
619.333.6703  
WWW.NAZENGINEERING.COM

ENGINEERS STAMP:

DATE SIGNED: 06/02/23

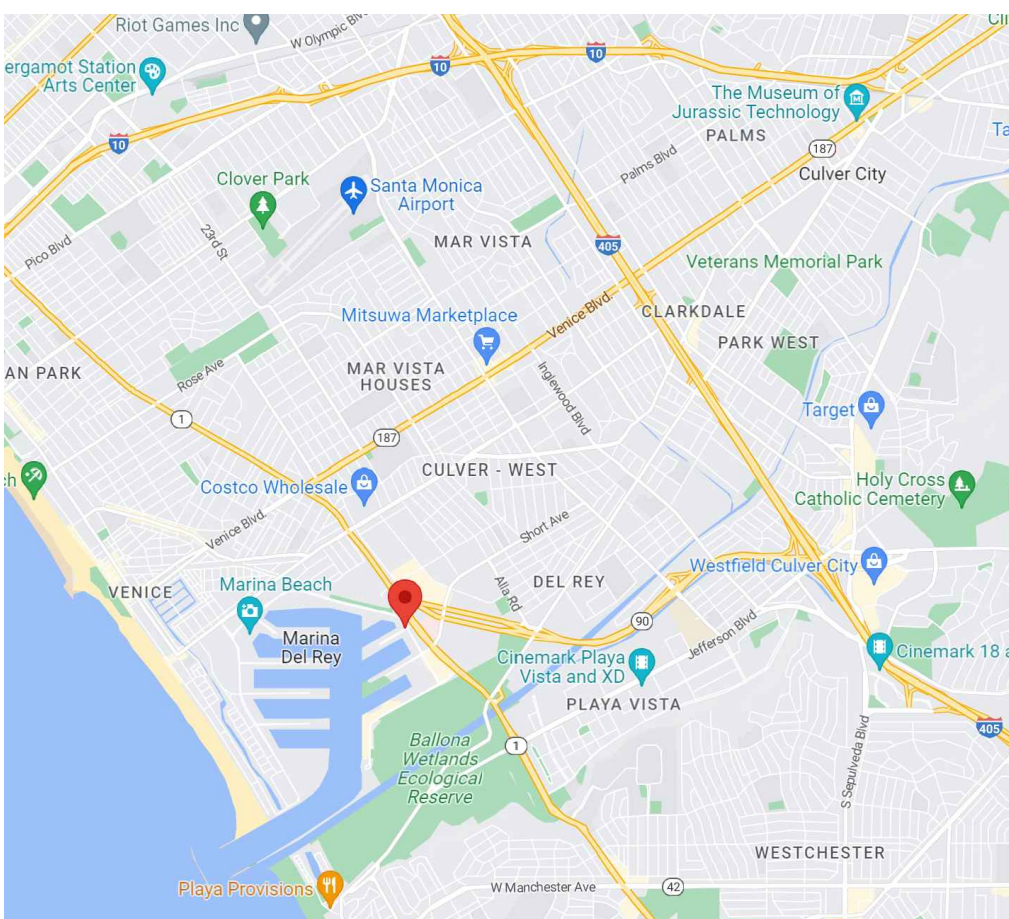VICINITY MAP		SHEET INDEX		GENERAL NOTES		PROJECT CONTACTS		PROJECT SCOPE OF WORK																							
		<table><tr><th colspan="2">Sheet List Table</th></tr><tr><th>SHEET #</th><th>SHEET TITLE</th></tr><tr><td>T100</td><td>TITLE SHEET</td></tr><tr><td>E001</td><td>ELECTRICAL NOTES &amp; ABBREVIATIONS</td></tr><tr><td>E101</td><td>OVERALL ELECTRICAL SITE PLAN</td></tr><tr><td>E102</td><td>ELECTRICAL LAYOUT PLAN</td></tr><tr><td>E201</td><td>ELECTRICAL SINGLE LINE DIAGRAM</td></tr><tr><td>E202</td><td>CALCULATIONS AND PANEL SCHEDULES</td></tr><tr><td>E301</td><td>ELECTRICAL DETAILS</td></tr><tr><td>E302</td><td>ELECTRICAL DETAILS</td></tr><tr><td>E401</td><td>EQUIPMENT DATASHEETS</td></tr></table>		Sheet List Table		SHEET #	SHEET TITLE	T100	TITLE SHEET	E001	ELECTRICAL NOTES & ABBREVIATIONS	E101	OVERALL ELECTRICAL SITE PLAN	E102	ELECTRICAL LAYOUT PLAN	E201	ELECTRICAL SINGLE LINE DIAGRAM	E202	CALCULATIONS AND PANEL SCHEDULES	E301	ELECTRICAL DETAILS	E302	ELECTRICAL DETAILS	E401	EQUIPMENT DATASHEETS	<ol style="list-style-type: none"><li>ANY PROPOSED HOT WORK SHALL BE CONDUCTED UNDER AN APPROVED EH&amp;S FIRE, LIFE AND GENERAL SAFETY DIVISION HOT WORK PERMIT. ALL HOT WORK PERMITS SHALL BE SUBMITTED AND APPROVED A MINIMUM OF 72 HOURS PRIOR TO ANY HOT WORK OPERATIONS BEGINNING AT THE PROJECT SITE.</li><li>PROVIDE ALL MATERIALS AND LABOR AS REQUIRED TO ACHIEVE A COMPLETE AND OPERATIONAL SYSTEM.</li><li>COORDINATE AND OBTAIN APPROVALS FROM ALL RESPECTIVE UTILITY COMPANIES AS REQUIRED FOR A COMPLETE AND FUNCTIONAL INSTALLATION.</li><li>EQUIPMENT LOCATIONS SHALL BE VERIFIED WITH ARCHITECTURAL DRAWINGS AS WELL AS EQUIPMENT SUPPLIER REQUIREMENTS PRIOR TO ANY ROUGH-IN WORK.</li><li>THESE DRAWINGS ARE DIAGRAMMATIC AND REPRESENT THE INTENT OF EQUIPMENT, DEVICES, ETC... TO BE CONNECTED AND THE CIRCUITS TO WHICH THEY ARE TO BE CONNECTED TO. CONTRACTOR SHALL INSTALL ALL CONDUIT, J-BOXES, ETC... AS REQUIRED FOR A COMPLETE AND OPERATIONAL SYSTEM.</li><li>ELECTRICAL CONTRACTOR SHALL VISIT SITE PRIOR TO BID DATE, TO VERIFY ALL EXISTING CONDITIONS TO BE ENCOUNTERED IN THE INSTALLATION OF ALL NEW EQUIPMENT, FIXTURES, DEVICES, FEEDERS, ETC... EXACT INSTALLATION METHOD AND REQUIREMENTS SHALL BE VERIFIED AND DETERMINED PRIOR TO BID DATE. CONTRACTORS SHALL IMMEDIATELY NOTIFY THIS ENGINEER OF ANY REQUIRED MODIFICATIONS WHICH ARE NOT SHOWN ON THESE DRAWINGS. SUBMITTAL OF BID INDICATES CONTRACTOR IS AWARE OF ALL JOB SITE CONDITIONS AND WORK TO BE PERFORMED.</li><li>COMPLETE ELECTRICAL SYSTEM SHALL BE GROUNDED IN ACCORDANCE WITH THE PRESENTLY ADOPTED EDITION OF THE NEC ARTICLE 250.</li><li>ALL ELECTRICAL EQUIPMENT SHALL BE LISTED BY UL OR AN APPROVED THIRD PARTY TESTING FACILITY. 110.3(b).</li><li>DUE TO VOLTAGE DROP AS INDICATED IN ELECTRICAL PLANS, BRANCH CIRCUITS MAY HAVE OVERSIZED CONDUCTORS TERMINATING AT BOTH BRANCH PANEL AND DEVICE/EQUIPMENT CONNECTION. ELECTRICAL CONTRACTOR SHALL MAKE PROVISIONS FOR THESE OVERSIZED CONDUCTORS AND INCLUDE LUG KITS AS REQUIRED.</li><li>DURING CONSTRUCTION, AT LEAST ONE EXTINGUISHER SHALL BE PROVIDED D ON EACH FLOOR LEVEL AT EACH STAIRWAY, IN ALL STORAGE AND CONSTRUCTION SHEDS, IN LOCATIONS WHERE FLAMMABLE OR COMBUSTIBLE LIQUIDS ARE STORED USED, AND WHERE OTHER SPECIAL HAZARDS ARE PRESENT PER CBC 3315.</li><li>DUMPSTERS AND TRASH CONTAINERS EXCEEDING 1.5 CUBIC YARDS SHALL NOT BE STORED IN BUILDING OR PLACED WITHIN 5 FEET OF COMBUSTIBLE WALLS, OPENINGS PR COMBUSTIBLE ROOF EAVE LINES UNLESS PROTECTED BY AN APPROVED SPRINKLER SYSTEM OR LOCATED IN A TYPE I OR IIA STRUCTURE SEPARATED BY 10 FEET FROM OTHER STRUCTURES. CONTAINERS LARGER THAN 1 CUBIC YARD SHALL BE OF NON- OR LIMITED-COMBUSTIBLE MATERIALS OR SIMILARLY PROTECTED OR SEPARATED PER CBC 304.4.</li><li>THE EGRESS PATH SHALL REMAIN FREE AND CLEAR OF ALL OBSTRUCTIONS AT ALL TIMES. NO STORAGE IS PERMITTED IN ANY EGRESS PATHS PER CBC 3301.2.</li><li>CLEAR FLOORS SPACE OF 48" BY 30" IN FRONT OF ACCESSIBLE EVCS SHALL BE PROVIDED PER CBC SECTION 11B-305.</li><li>ACCESSIBLE VEHICLE SPACES, ACCESS AISLES SERVING THEM, AND VEHICULAR ROUTES SERVING THEM SHALL BE PROVIDED A VERTICAL CLEARANCE OF 98" MINIMUM PER CBC SECTION 11B-812.4.</li><li>AT ACCESSIBLE STALL THE RUNNING SLOPE AND CROSS SLOPE FOR THE VEHICLE SPACE AND ACCESS AISLE NOT TO EXCEED 1:48 PER CBC SECTION 11B-812.3.</li><li>AT HAZARDOUS VEHICULAR AREAS, DETECTABLE WARNING SURFACES SHALL BE YELLOW CONFORMING TO FS 33538 OF FEDERAL STANDARD 595C.</li><li>ONLY APPROVED DSA-AC DETECTABLE WARNING PRODUCTS AND DIRECTIONAL SURFACES SHALL BE INSTALLED AS PROVIDED IN THE CALIFORNIA CODE OF REGULATIONS (CCR), TITLE 24, PART 1, CHAPTER 5, ARTICLE 2, 3 AND 4.</li><li>NO WORK IS PROPOSED WITHIN A PUBLIC EASEMENT.</li><li>ALL ELECTRICAL EQUIPMENT SHALL BE LABELED, LISTED, OR CERTIFIED BY A NATIONALLY RECOGNIZED TESTING LABORATORY ACCREDITED BY THE UNITED STATES OCCUPATIONAL SAFETY HEALTH ADMINISTRATION.</li><li>SUITABLE FOR REFERENCE. CONTRACTORS SHALL VERIFY ALL PLANS, EXISTING DIMENSIONS, FIELD CONDITIONS ON THE JOB SITE AND SHALL IMMEDIATELY NOTIFY THE ARCHITECT/ENGINEER IN WRITING OF ANY DISCREPANCIES BEFORE PROCEEDING WITH THE WORK OR BE RESPONSIBLE FOR SAME.</li></ol>		<div><div>OWNER REPRESENTATION: COUNTY OF LOS ANGELES 13837 FIJI WAY MARINA DEL REY, CA 90292 P.424.526.7756 CONTACT: WARREN ONTIVEROS</div><div>PERMITTING JURISDICTION: LOS ANGELES COUNTY DEPT. OF REGIONAL PLANNING 320 WEST TEMPLE STREET LOS ANGELES, CA 90012 P.213.974.6411</div><div>COUNTY: LOS ANGELES COUNTY</div><div>POWER COMPANY: SOUTHERN CALIFORNIA EDISON</div><div>DEVELOPER: POWERFLEX 392 FIRST STREET LOS ALTOS, CA 94022 P.650.469.3392</div><div>ENGINEERING FIRM: NAZARENE ENGINEERING 2514 JAMACHA RD. #502-182 EL CAJON, CA 92019 P.619.333.6703</div></div> <div><div>THE SCOPE OF WORK FOR THIS PROJECT CONSISTS OF (40) EV CHARGING STATIONS DESIGNATED ON THIS PLAN AS SYSTEM A AND SYSTEM B PER THE FOLLOWING:</div><div><div>SYSTEM A</div><div><ul style="list-style-type: none"><li>(20) ALL-IN-ONE 7.7KW EV CHARGERS</li><li>(1) 400A DISTRIBUTION BOARD 'EVA1'</li><li>(1) LOAD MANAGEMENT CONTROLLER ENCLOSURE</li></ul></div><div>SYSTEM B</div><div><ul style="list-style-type: none"><li>(20) ALL-IN-ONE 7.7KW EV CHARGERS</li><li>(1) 400A DISTRIBUTION BOARD 'EVB1'</li></ul></div><div>DISTRIBUTION BOARDS 'EVA1' AND 'EVB1' SHALL BE ROUTED TO:</div><div><ul style="list-style-type: none"><li>(1) 150KVA TRANSFORMER 'XEVI1'</li><li>(1) 400A PANELBOARD 'MSB'</li><li>(1) 400A CT AND METER CABINET</li><li>(1) 300KVA UTILITY TRANSFORMER</li></ul></div></div></div>			
Sheet List Table																															
SHEET #	SHEET TITLE																														
T100	TITLE SHEET																														
E001	ELECTRICAL NOTES & ABBREVIATIONS																														
E101	OVERALL ELECTRICAL SITE PLAN																														
E102	ELECTRICAL LAYOUT PLAN																														
E201	ELECTRICAL SINGLE LINE DIAGRAM																														
E202	CALCULATIONS AND PANEL SCHEDULES																														
E301	ELECTRICAL DETAILS																														
E302	ELECTRICAL DETAILS																														
E401	EQUIPMENT DATASHEETS																														
								INTERNAL STAMP																							
								<div><div><div><div>SITE PLAN REVIEW</div><div>PERMIT #: RPPL2023006183</div><div>PROJECT #: PRJ2023-004181</div><div>This plan is APPROVED in compliance with the Los Angeles County Zoning Code and subject to the requirements noted herein. This approval shall expire if it is not used within two years of the approval date and prior to any change in ordinance requirements. This approval shall not be construed to permit the violation of any provision of the Los Angeles County Code or State or Federal Law.</div><div><div> SIGNATURE</div><div>11-30-2023 APPROVAL DATE</div><div><div>Clark Taylor</div> PRINT</div><div>11-30-2025 EXPIRATION DATE</div></div></div><div><div>BUILDING AND SAFETY DIVISION Department of Public Works APPROVED UNDER LOS ANGELES COUNTY CODE TITLES 26, 30 AND 31 PUBLIC WORKS 09/13/2023 3:43:47 PM <small>This set of plans and specifications shall be kept at the job site at all times. Set it is unlawful to make any changes, modifications or alterations to these plans or specifications without the prior written permission of the Building Official. The stamping of this set of plans and specifications SHALL NOT, under any circumstances, be deemed to permit or to be an approval of any work or activity that violates any provisions of any County Ordinance or State Law.</small></div></div></div></div>		SITE ADDRESS MARINA DEL REY LOT 5																					
								DEPARTMENT OF REGIONAL PLANNING APPROVED																							
								SHEET TITLE TITLE SHEET																							
								SHEET NUMBER T100																							

PROJECT NUMBER: 2314-03

DRAWN BY: RF

CHECKED BY: JB

REVISIONS			
REV	DATE	DESCRIPTION	BY
0	05/12/23	IFP PLAN PACKAGE	JB
1	06/02/23	PLAN CHECK #1	JB

SITE ADDRESS

MARINA DEL REY LOT 5

DEPARTMENT OF  
REGIONAL PLANNING APPROVED

SHEET TITLE

TITLE SHEET

SHEET NUMBER


T100



A1

## EQUIPMENT LAYOUT ENLARGED DETAIL



SCALE: 1" = 5'

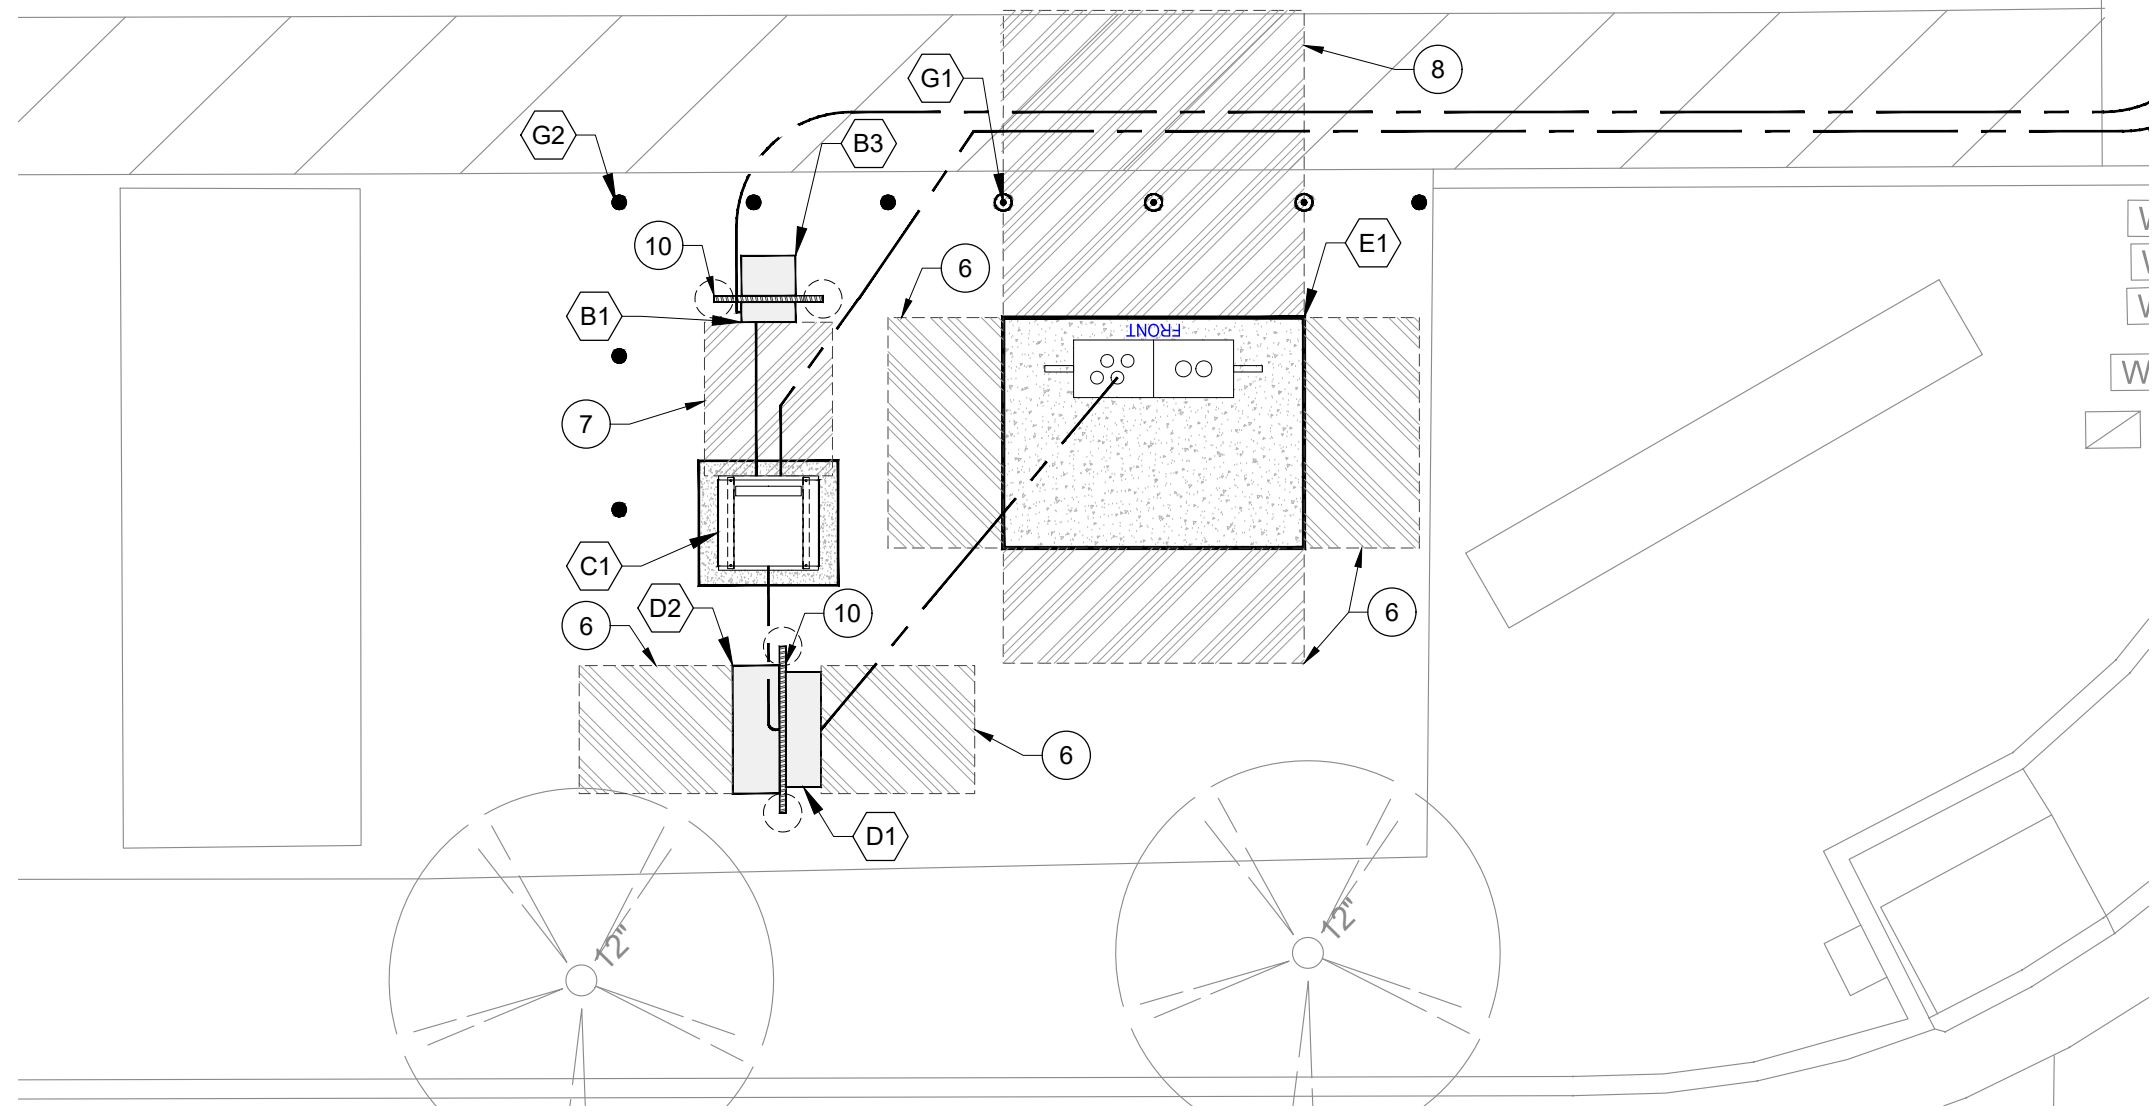

A2

## ACCESSIBLE RAMP AT EV STALLS #1-6 ENLARGED DETAIL


SCALE: 1" = 5'

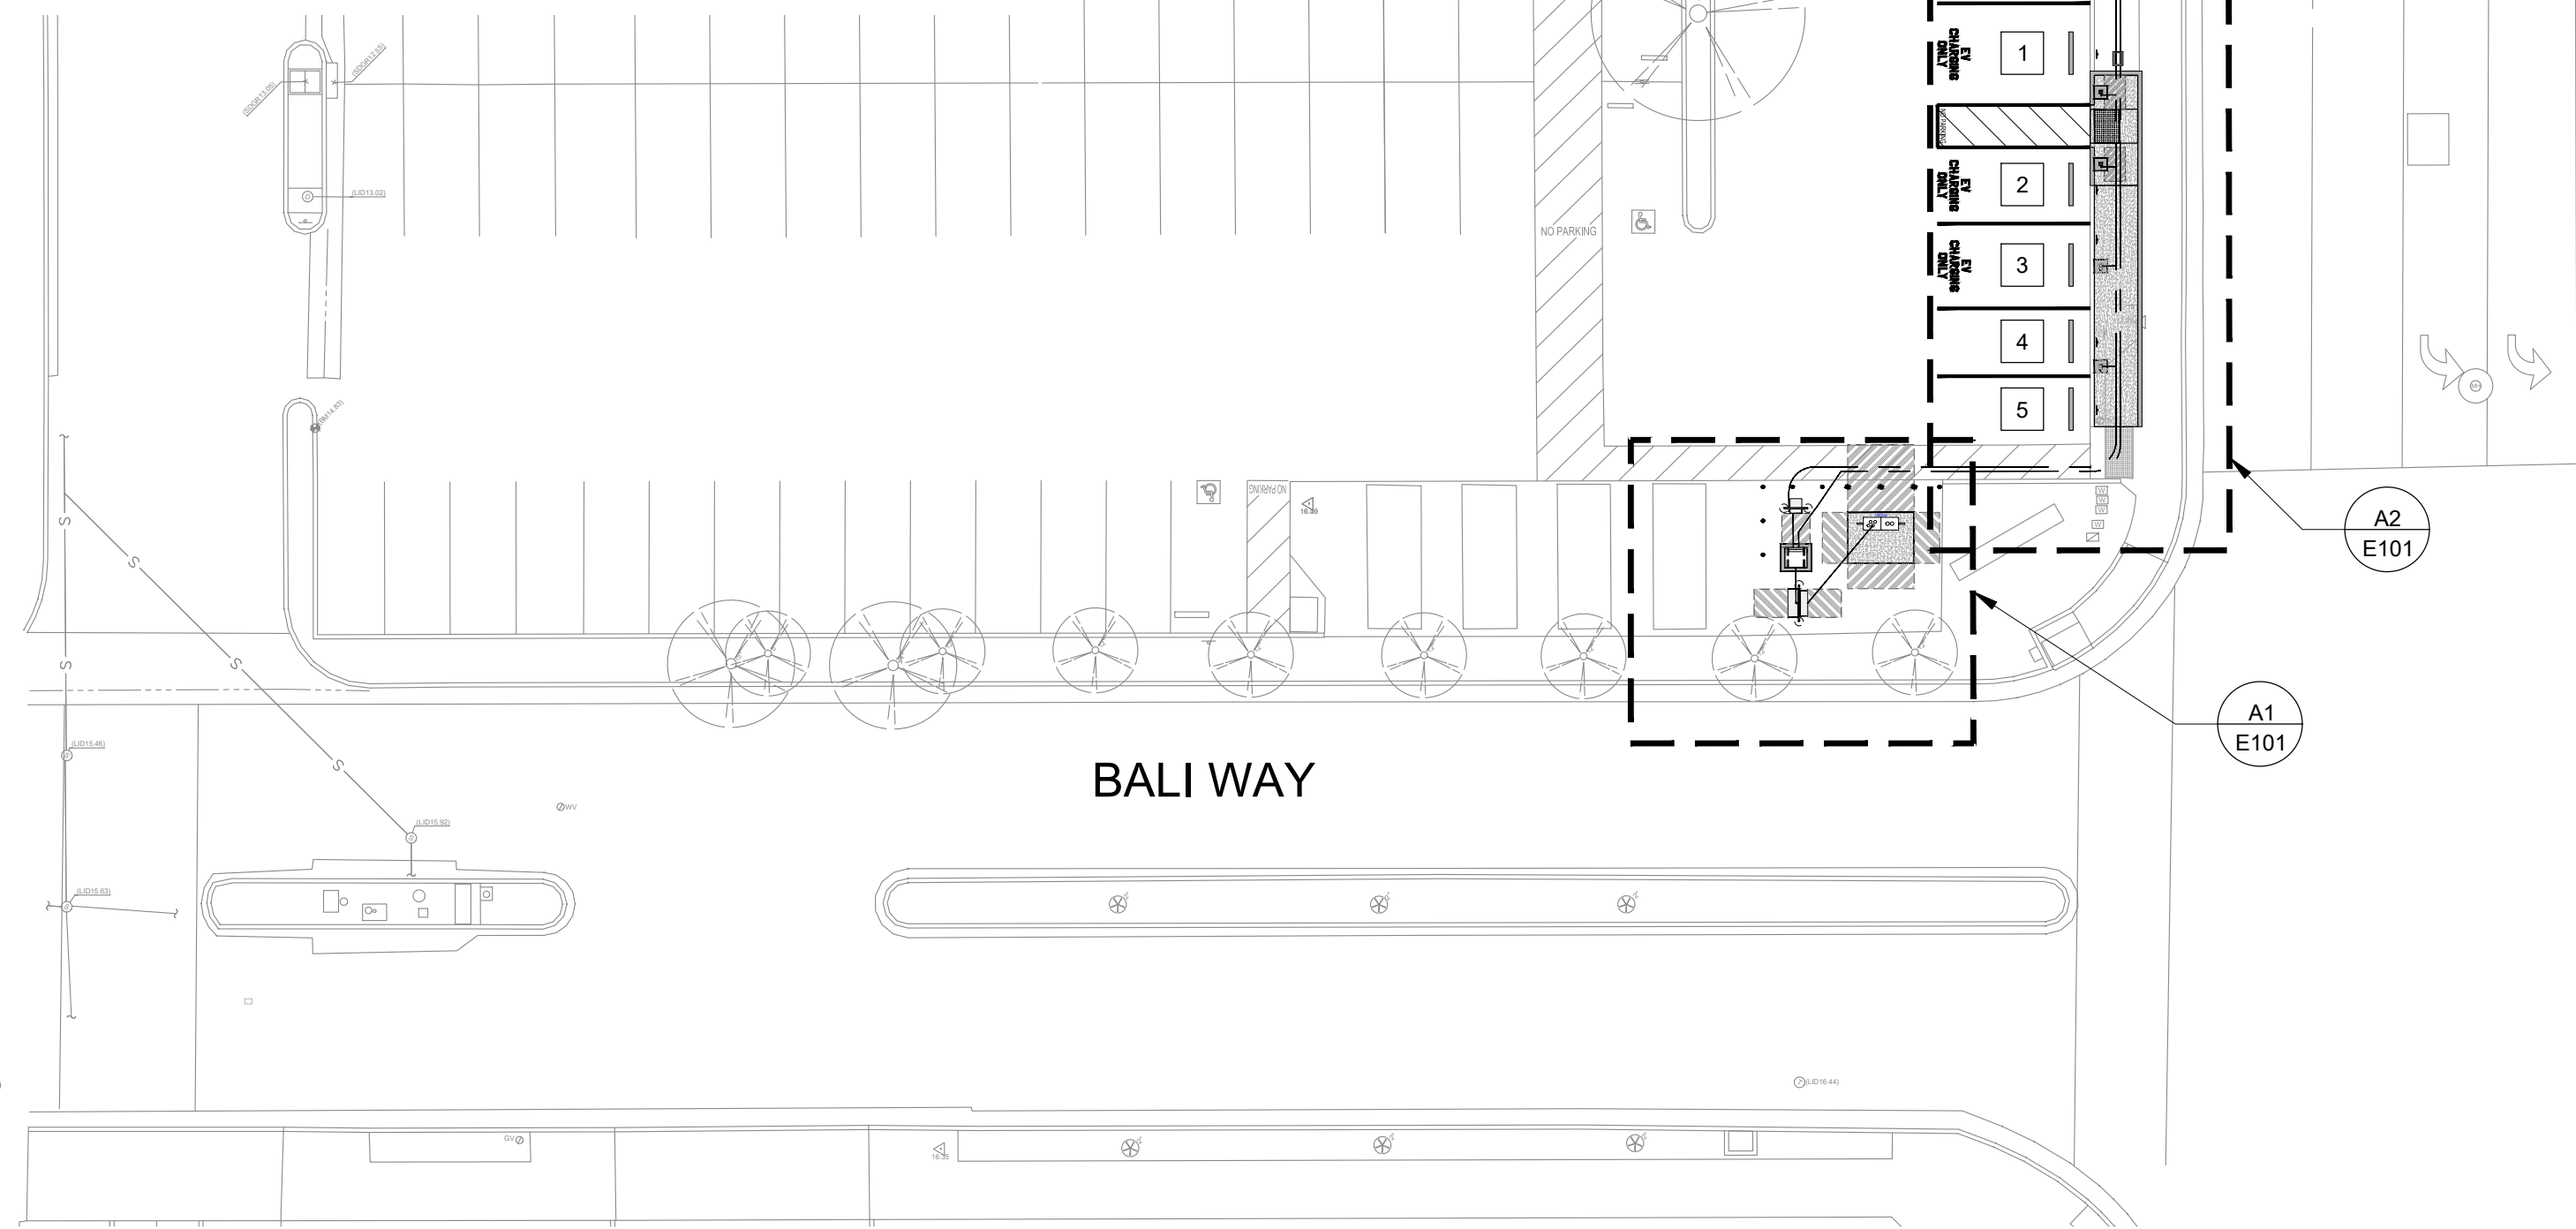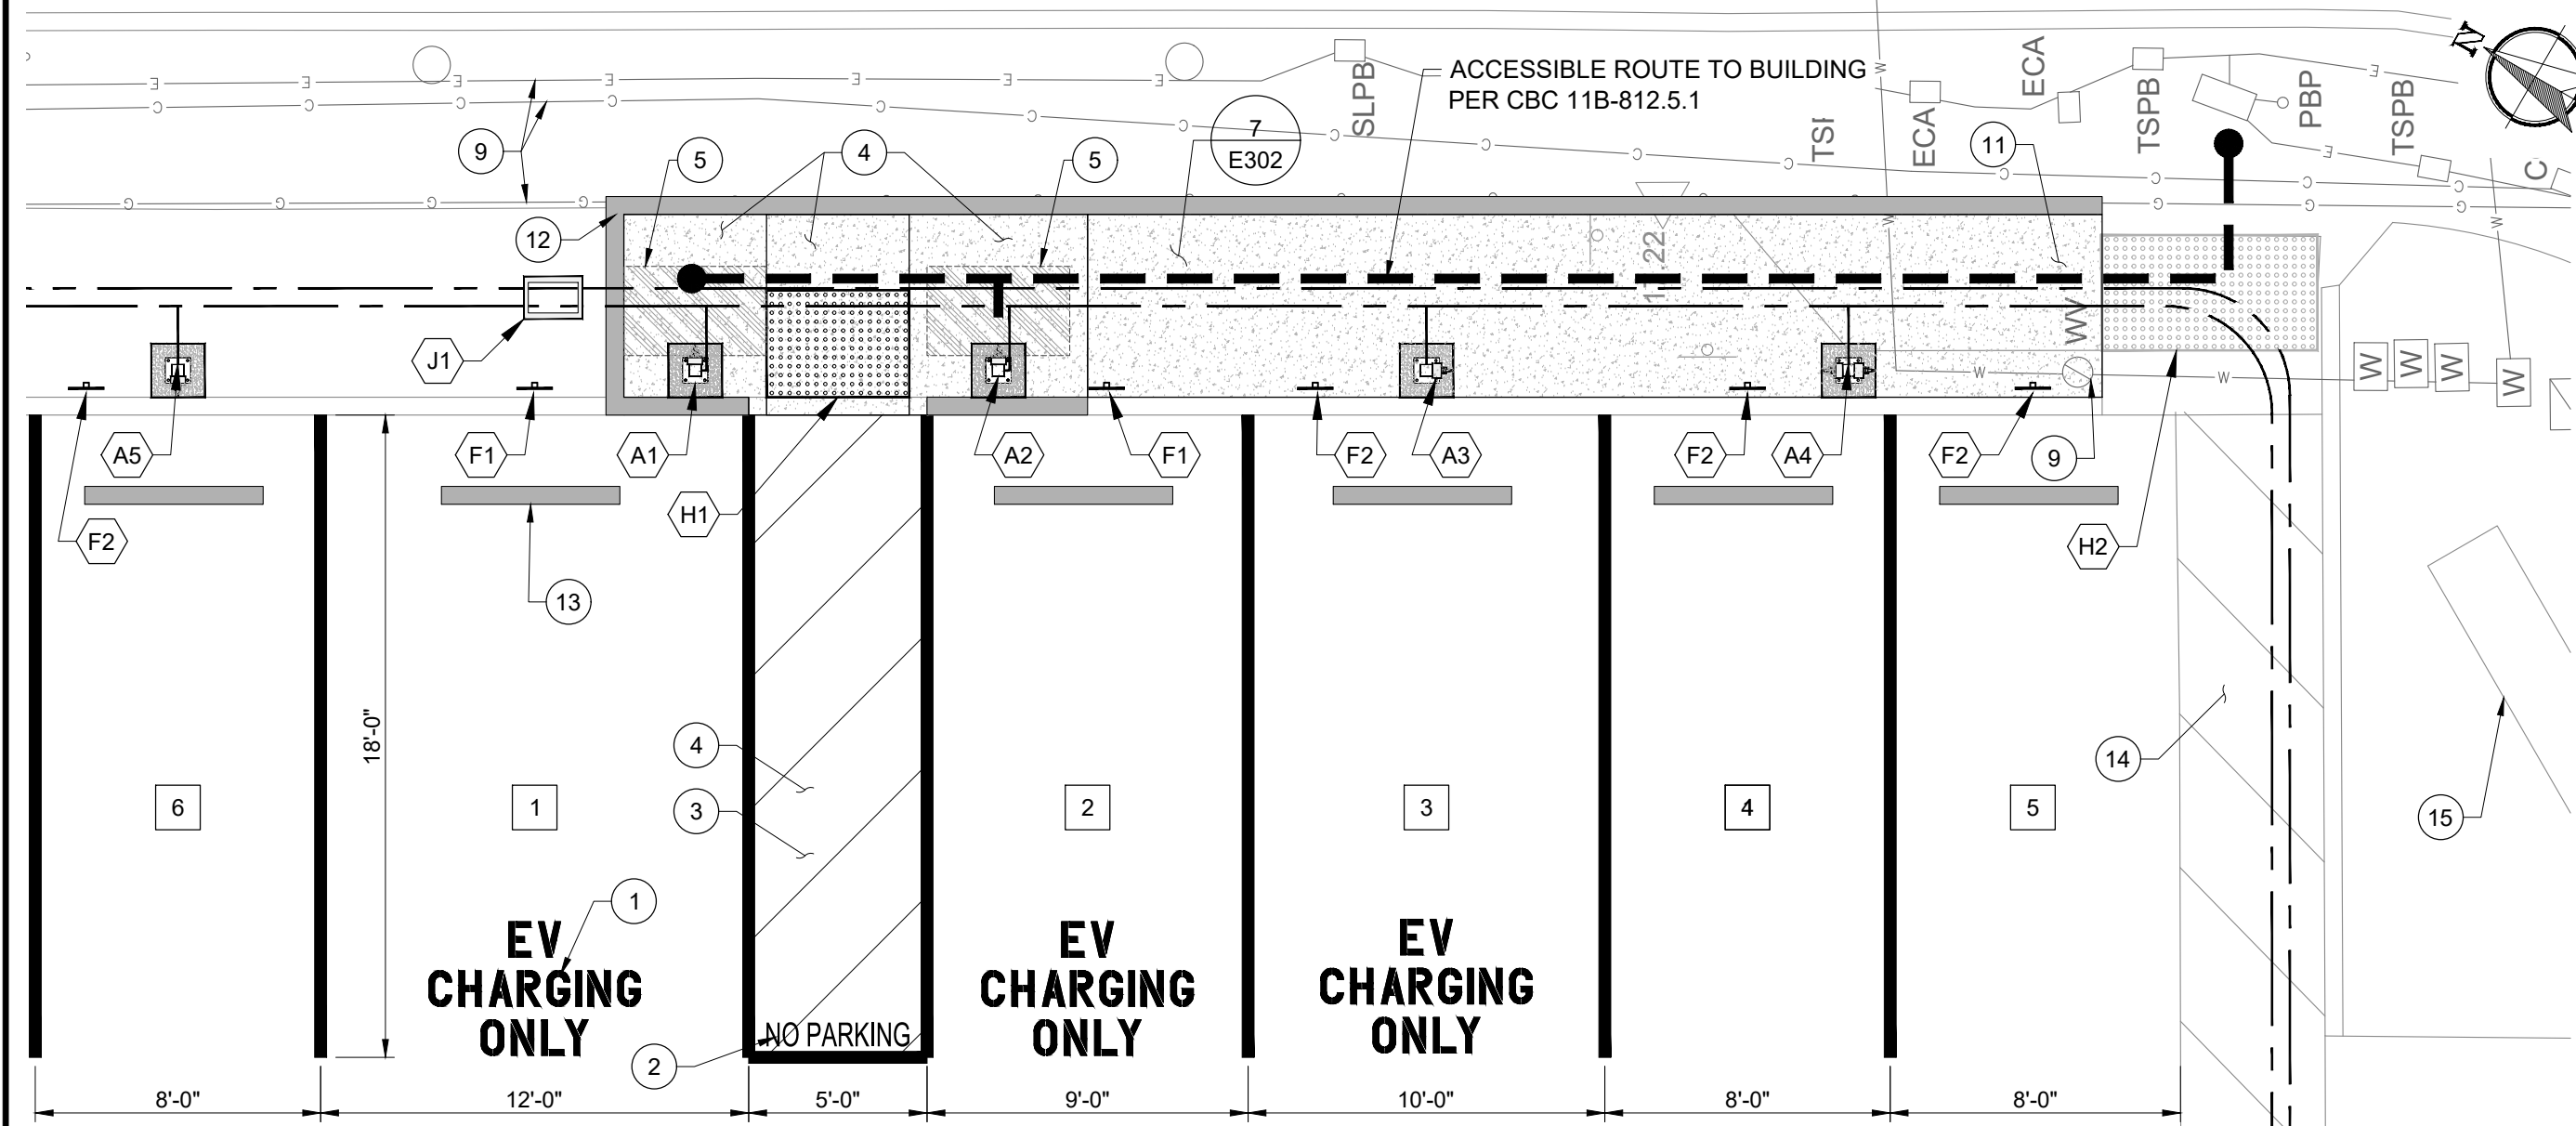

## OVERALL ELECTRICAL SITE PLAN

SCALE: 1" = 20'

## AERIAL VIEW

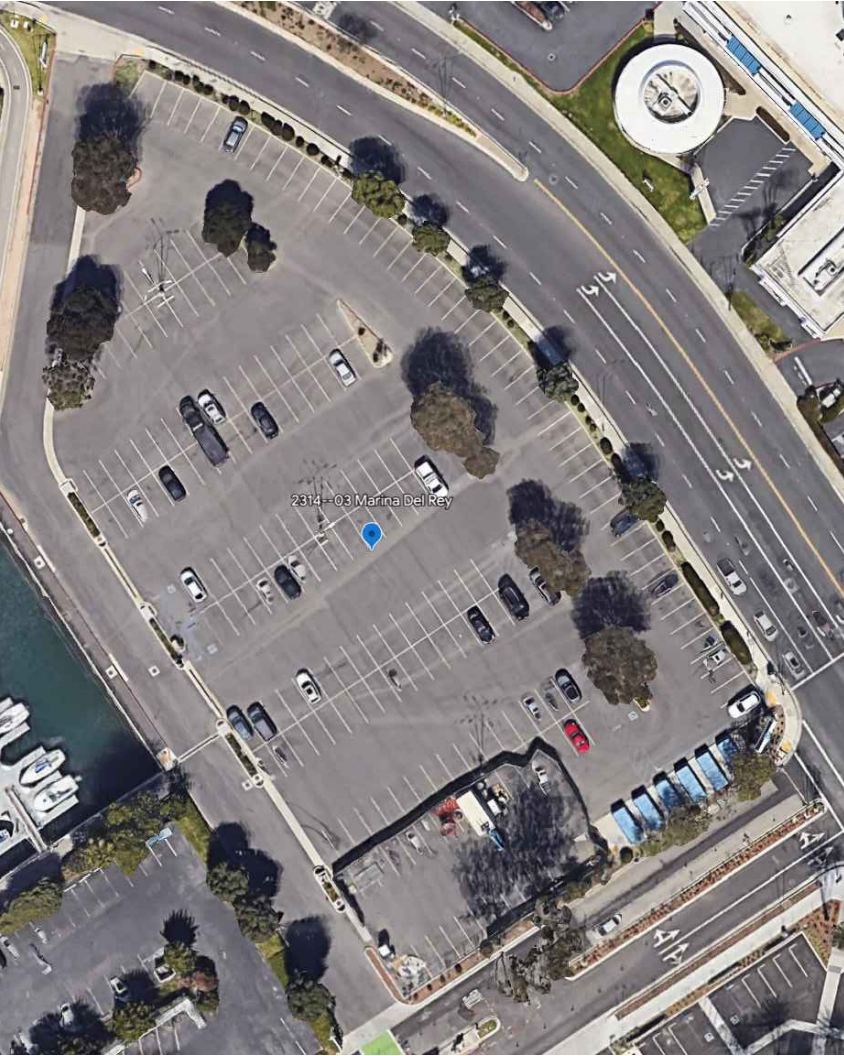

## EQUIPMENT SUMMARY

- |    |   |
|----|---|
| A1 | 7.7KW EV CHARGER VAN ACCESSIBLE STALL #1<br>SEE EQUIPMENT PAD DETAIL 1/E302 (SINGLE PEDESTAL)                           |
| A2 | 7.7KW EV CHARGER STANDARD ACCESSIBLE STALL #2<br>SEE EQUIPMENT PAD DETAIL 1/E302 (SINGLE PEDESTAL)                      |
| A3 | 7.7KW EV CHARGER AMBULATORY STALL #3<br>SEE EQUIPMENT PAD DETAIL 1/E302 (SINGLE PEDESTAL)                               |
| A4 | 7.7KW EV CHARGER STANDARD NON ACCESSIBLE STALLS #4-5 & 7-40<br>SEE EQUIPMENT PAD DETAIL 1/E302 (DUAL PEDESTAL)          |
| A5 | 7.7KW EV CHARGER STANDARD NON ACCESSIBLE STALL #6<br>SEE EQUIPMENT PAD DETAIL 1/E302 (SINGLE PEDESTAL)                  |
| B1 | SYSTEM A DISTRIBUTION BOARD 'EVA1' (STALLS #1-20)<br>SEE EQUIPMENT PAD DETAIL 2/E302                                    |
| B2 | SYSTEM B DISTRIBUTION BOARD 'EVB1' (STALLS #21-40)<br>SEE EQUIPMENT PAD DETAIL 2/E302                                   |
| B3 | LOAD MANAGEMENT CONTROLLER 'LMC'<br>SEE EQUIPMENT PAD DETAIL 7/E302   |
| C1 | TRANSFORMER 'XEV1'<br>SEE EQUIPMENT PAD DETAIL 3/E301   |
| D1 | MILBANK CT AND METER CABINET<br>STRUT MOUNTED   |
| D2 | PANELBOARD 'MSB'<br>STRUT MOUNTED   |
| E1 | UTILITY TRANSFORMER PAD PER SCE STANDARD<br>(75-500KVA, 3ø, 72"x94" CONCRETE PAD)                                       |
| F1 | 'EV CHARGING ONLY' PARKING SIGN<br>VAN AND STANDARD ACCESSIBLE STALLS #1-2<br>PER CBC 11B-812.8. SEE DETAIL 6/E301      |
| F2 | 'EV CHARGING' PARKING SIGN<br>AMBULATORY & STANDARD NON-ACCESSIBLE STALLS #3-40<br>PER CBC 11B-812.8. SEE DETAIL 6/E301 |
| G1 | UTILITY TRANSFORMER BOLLARD<br>PER UTILITY STANDARD   |
| G2 | PERMANENT BOLLARD (TYP.)<br>SEE DETAIL 5/E302   |
| H1 | DETECTABLE WARNING<br>SEE DETAIL 5/E301   |
| H2 | EXISTING DETECTABLE WARNING<br>PROTECT IN PLACE   |
| J1 | 11"x17" PULLBOX   |

## KEY NOTES

- ① 12" HIGH "EV CHARGING ONLY" SURFACE MARKING AT THE END OF EACH EVCS SPACE PER CBC 11B-812.9.
- ② "NO PARKING" WORDS ON THE SURFACE OF THE ACCESS AISLE TO BE 2'-2' MIN. IN HEIGHT AND LOCATED TO BE VISIBLE FROM THE ADJACENT VEHICULAR WAY PER CBC 11B-812.7.3.
- ③ ACCESS AISLE SHALL BE PAINTED A COLOR OTHER THAN BLUE REQUIRED FOR IDENTIFICATION FOR REGULAR ACCESS AISLES PER CBC 11B-812.7.2.
- ④ SLOPE OF WALKING SURFACES TO BE 2% MAXIMUM IN EVERY DIRECTION AT THE VAN ACCESSIBLE AND STANDARD ACCESSIBLE STALLS, ACCESS AISLE AND IN FRONT OF THE EV CHARGING STATION PER CBC 11B-812.3.
- ⑤ 30"x48" EQUIPMENT CLEAR SPACE FOR PARALLEL APPROACH PER CBC 11B-305.
- ⑥ 36" LEVEL EQUIPMENT CLEARANCE PER NEC 110.26.
- ⑦ 48" LEVEL EQUIPMENT CLEARANCE PER NEC 11
- ⑧ 8' LEVEL EQUIPMENT CLEARANCE PER UTILITY :
- ⑨ CONTRACTOR SHALL POTHOLE EXACT LOCATIONS AND RELOCATE CONDUITS PRIOR TO INSTALLING EQUIPMENT AND RELOCATE EXISTING CONDUIT AS REQUIRED.
- ⑩ PROPOSED UNISTRUT EQUIPMENT RACK.
- ⑪ PROPOSED 4" THICK CONCRETE WALKWAY (5% MAX) SHALL CONNECT INTO EXISTING WALKWAY PER CBC AND AHJ REQUIREMENTS.
- ⑫ INSTALL VARIABLE HEIGHT CURB (6" MAX)
- ⑬ INSTALL WHEEL STOP (TYP.)
- ⑭ EXISTING ACCESS AISLE TO REMAIN. PROTECT IN PLACE.
- ⑮ EXISTING SIGN. PROTECT IN PLACE.



DEVELOPER:




ELECTRICAL ENGINEER

nazarene engineering

**NAZARENE ENGINEERING**  
2514 JAMACHA RD. #502-182  
EL CAJON, CA 92019  
619.333.6703  
[WWW.NAZENGINEERING.COM](http://WWW.NAZENGINEERING.COM)

ENGINEERS STAMP

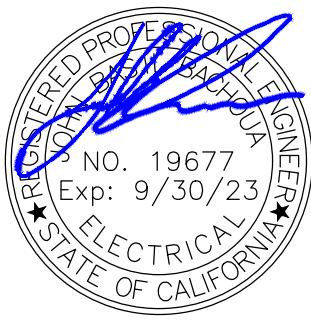

DATE SIGNED: 06/02/23

PROJECT NUMBER: 2314-03

DRAWN BY: RF

CHECKED BY: JB

## REVISIONS

REV	DATE	DESCRIPTION	B'Y
0	05/12/23	IFP PLAN PACKAGE	JL
1	06/02/23	PLAN CHECK #1	JL

## SITE ADDRESS

MARINA DEI REV I NT 5

**DEPARTMENT OF  
REGIONAL PLANNING APPROVED**



## SHEET TITLE

# OVERALL ELECTRICAL SITE PLAN

SHEET NUMBER

E101

A

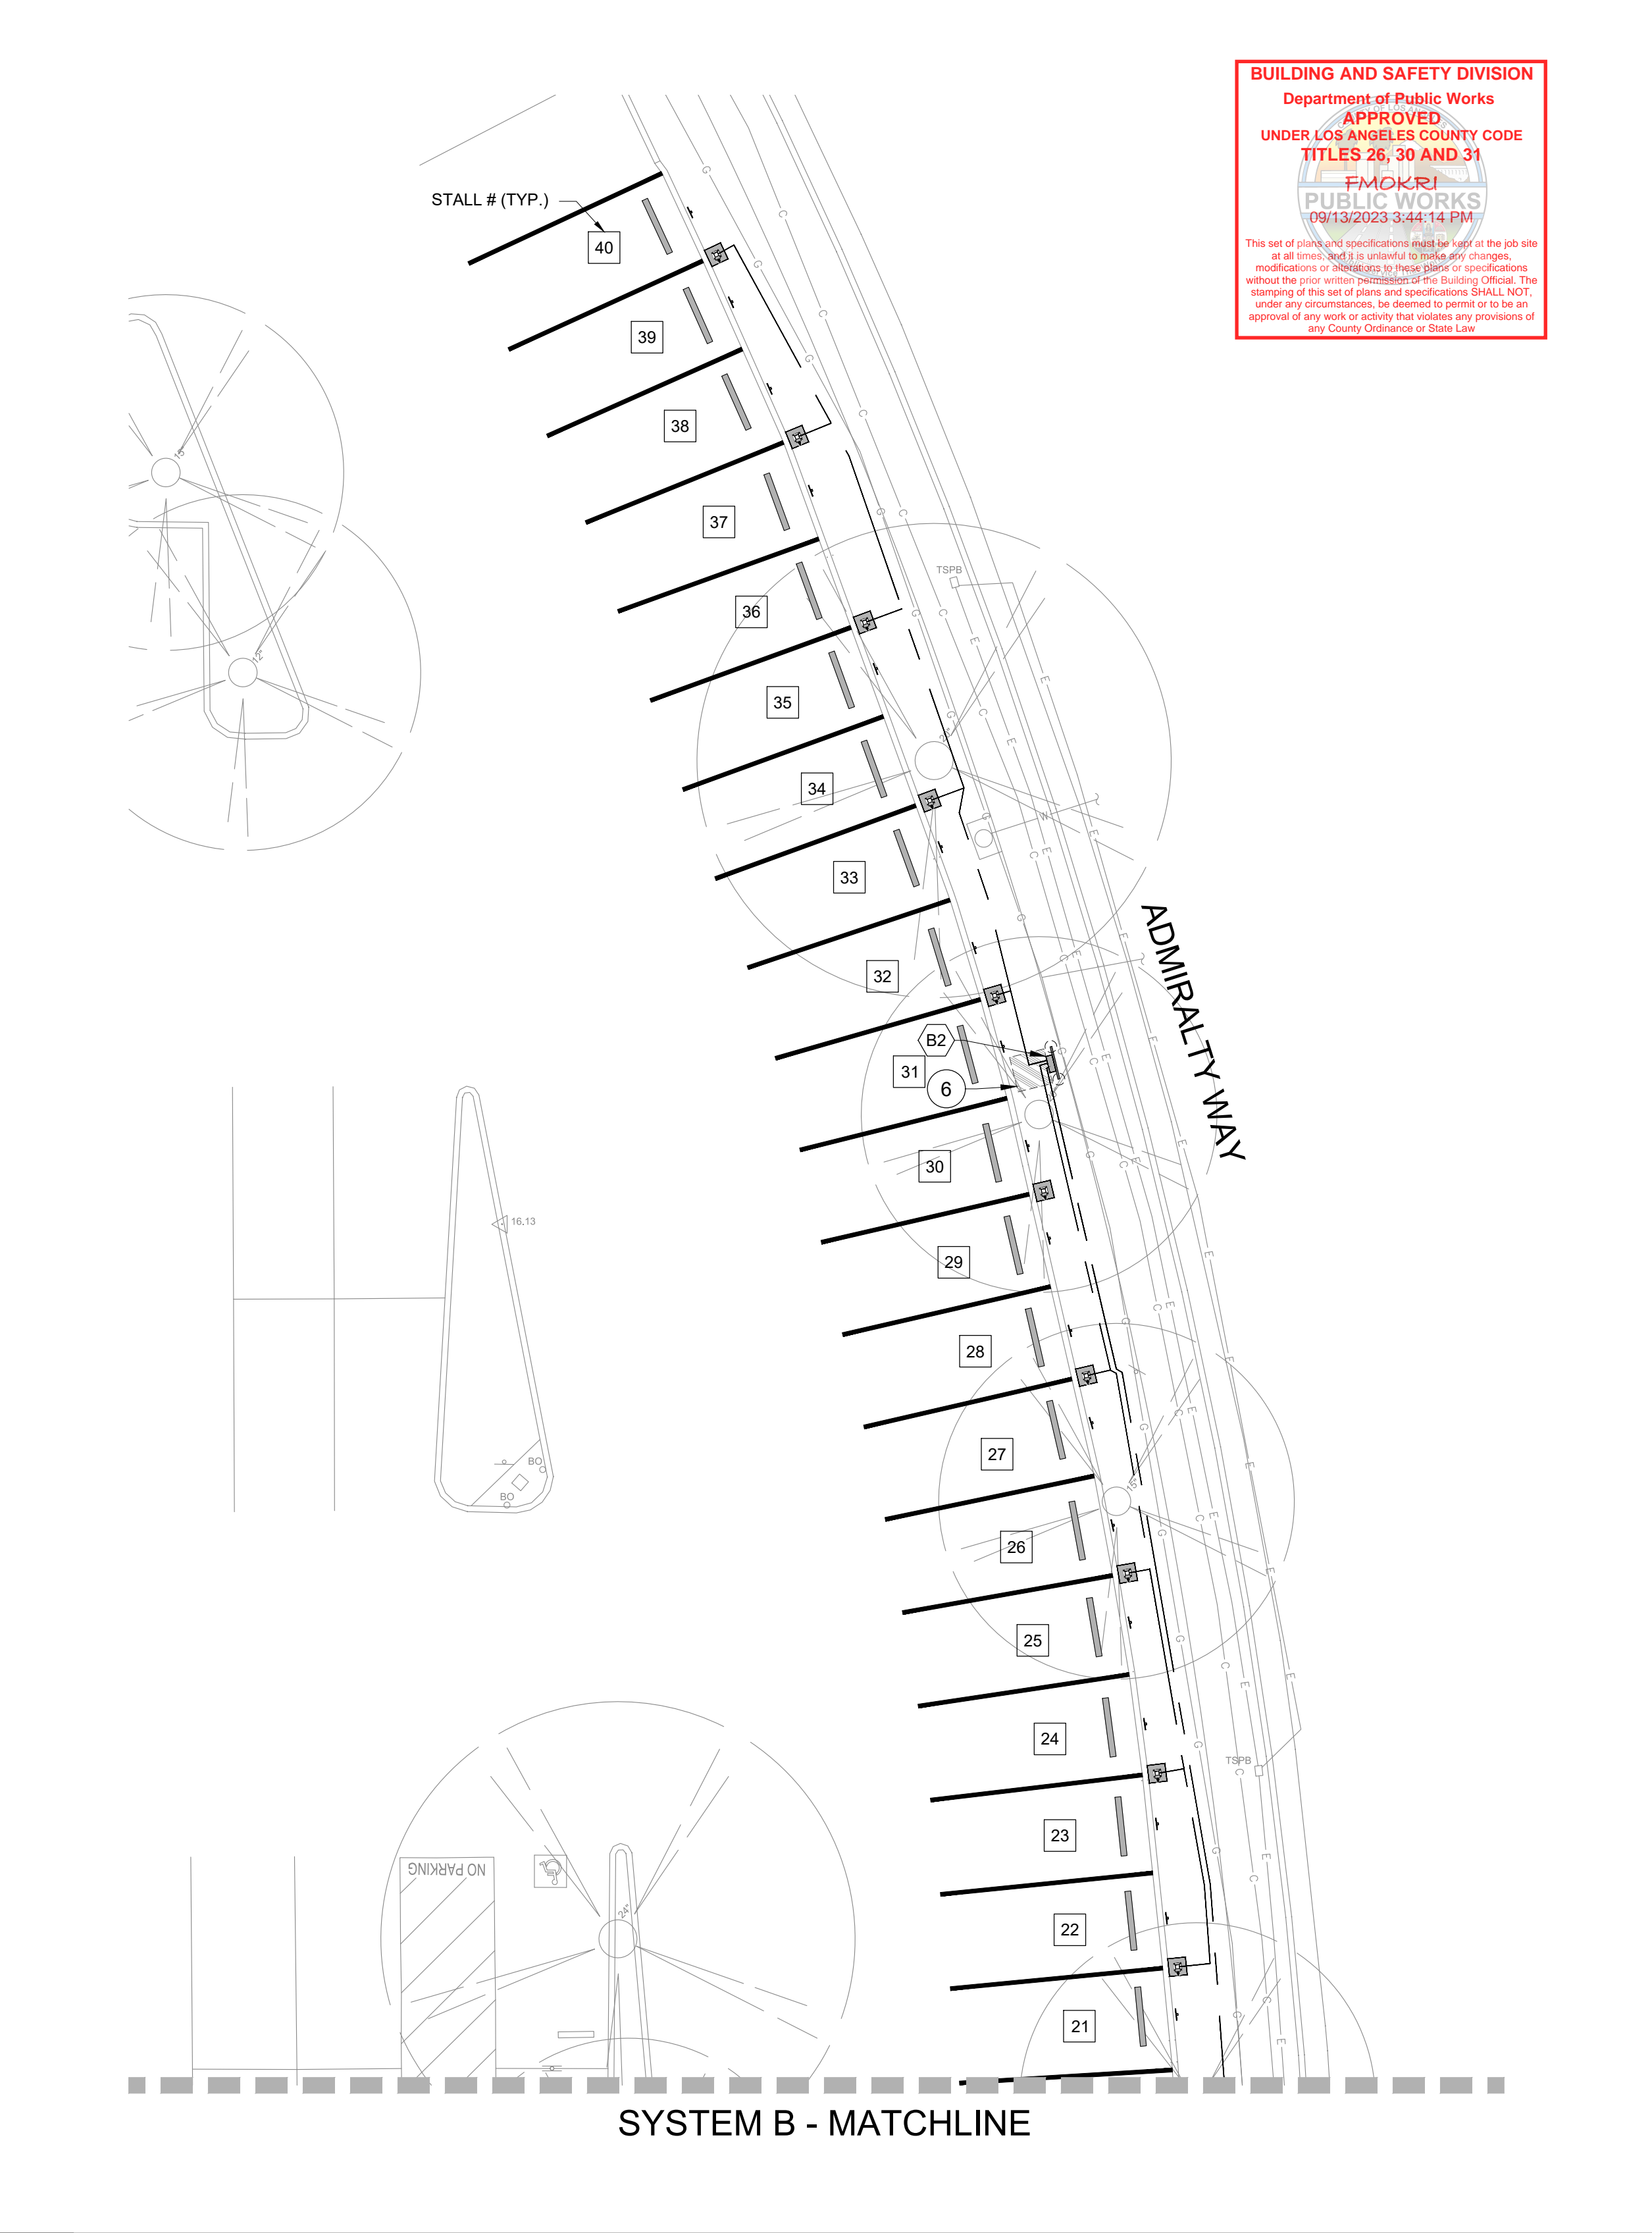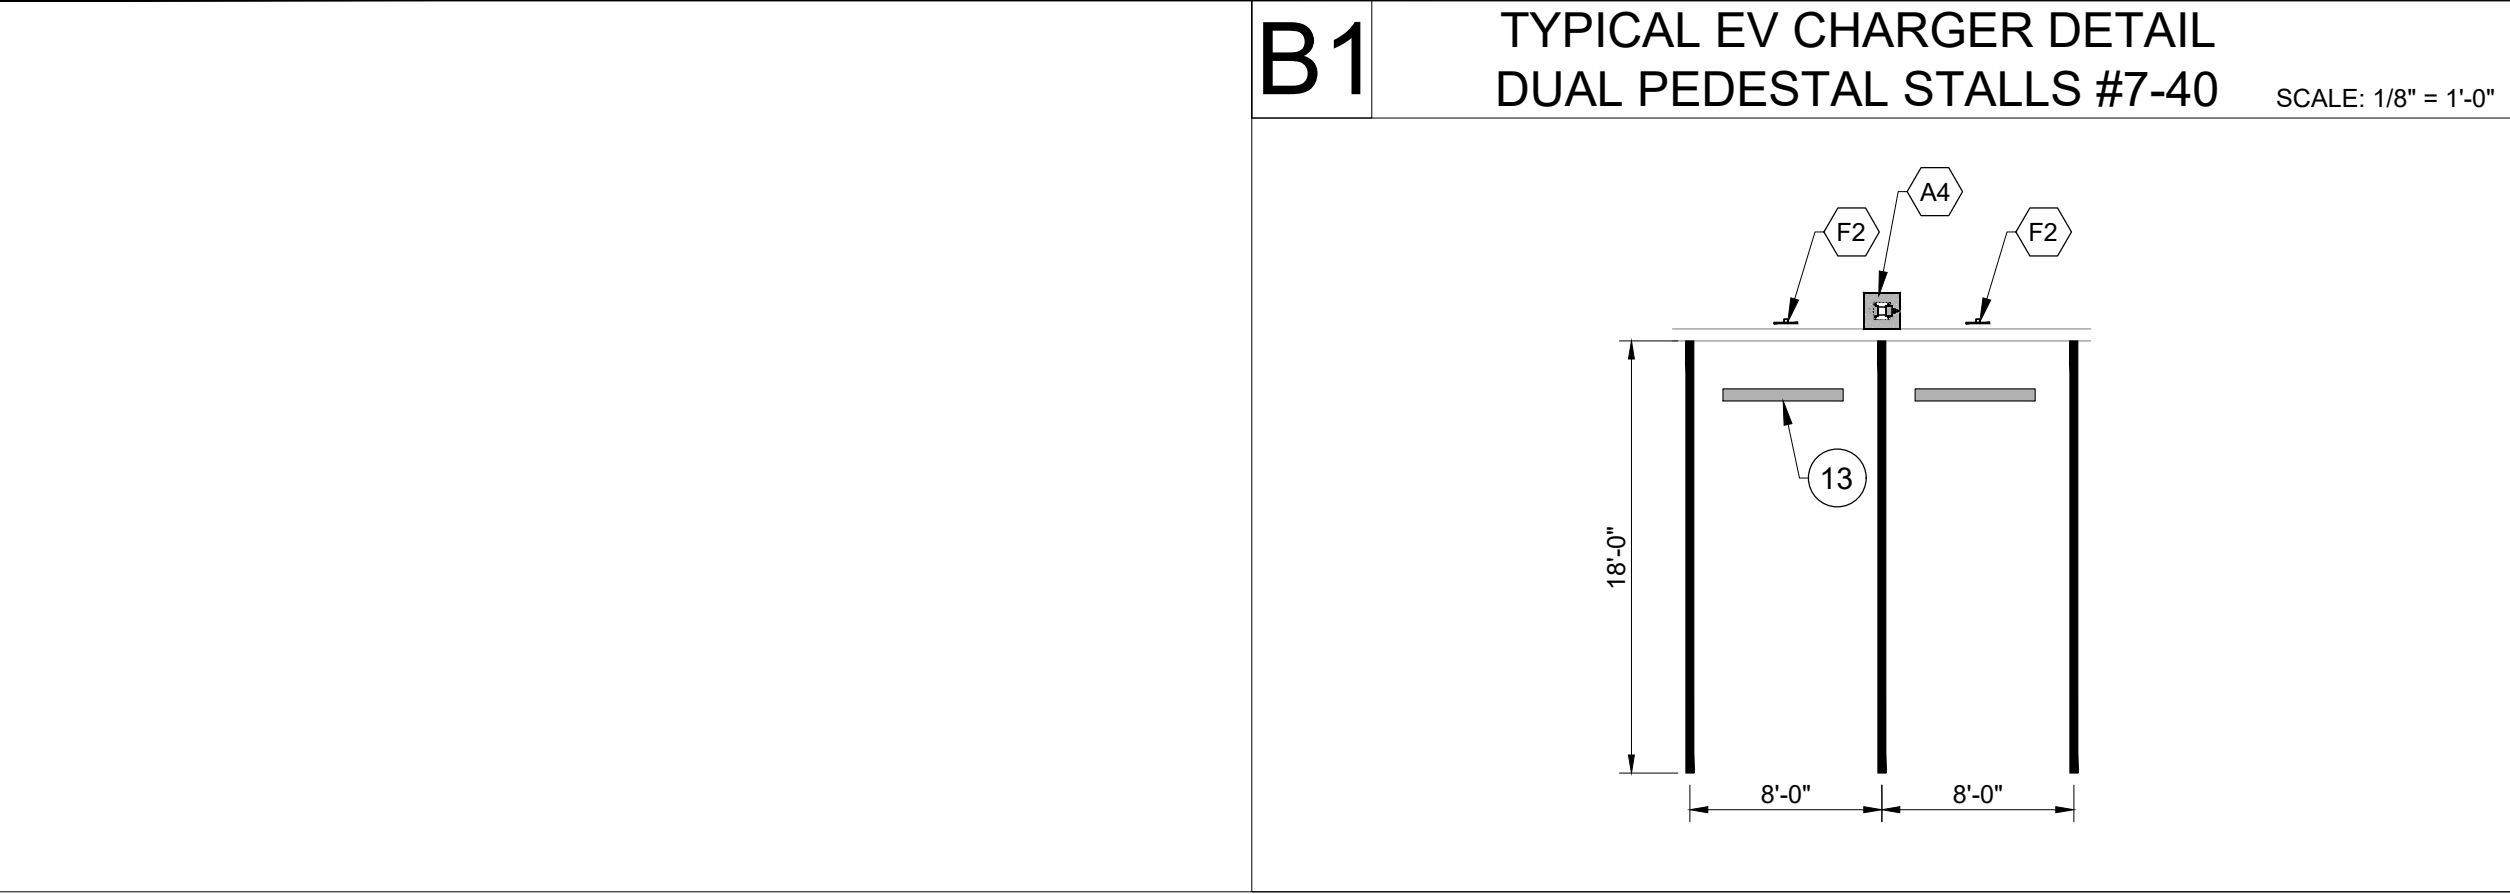

ELECTRICAL LAYOUT PLAN

THE USE OF THESE PLANS AND SPECIFICATIONS SHALL BE RESTRICTED TO THE ORIGINAL SITE FOR WHICH THEY WERE PREPARED AND PUBLICATION THEREOF IS EXPRESSLY LIMITED TO SUCH USE. REPRODUCTION, PUBLICATION, OR RE-USE BY ANY METHOD, IN WHOLE OR IN PART WITHOUT THE EXPRESS CONSENT OF NAZARENE ENGINEERING IS PROHIBITED.

EQUIPMENT SCHEDULE

- A1 7.7KW EV CHARGER VAN ACCESSIBLE STALL #1  
SEE EQUIPMENT PAD DETAIL 1/E302 (SINGLE PEDESTAL)
- A2 7.7KW EV CHARGER STANDARD ACCESSIBLE STALL #2  
SEE EQUIPMENT PAD DETAIL 1/E302 (SINGLE PEDESTAL)
- A3 7.7KW EV CHARGER AMBULATORY STALL #3  
SEE EQUIPMENT PAD DETAIL 1/E302 (SINGLE PEDESTAL)
- A4 7.7KW EV CHARGER STANDARD NON ACCESSIBLE STALLS #4-5 & 7-40  
SEE EQUIPMENT PAD DETAIL 1/E302 (SINGLE PEDESTAL)
- A5 7.7KW EV CHARGER STANDARD NON ACCESSIBLE STALL #6  
SEE EQUIPMENT PAD DETAIL 1/E302 (SINGLE PEDESTAL)
- B1 SYSTEM A DISTRIBUTION BOARD 'EVA1' (STALLS #1-20)  
SEE EQUIPMENT PAD DETAIL 2/E302
- B2 SYSTEM B DISTRIBUTION BOARD 'EVB1' (STALLS #21-40)  
SEE EQUIPMENT PAD DETAIL 2/E302
- B3 LOAD MANAGEMENT CONTROLLER 'LMC'  
SEE EQUIPMENT PAD DETAIL 7/E302
- C1 TRANSFORMER 'XEV1'  
SEE EQUIPMENT PAD DETAIL 3/E302
- D1 MILBANK CT AND METER CABINET  
STRUT MOUNTED
- D2 PANELBOARD 'MSB'  
STRUT MOUNTED
- E1 UTILITY TRANSFORMER PAD PER SCE STANDARD  
(75-500KVA, 3 $\phi$ , 72"x94" CONCRETE PAD)
- F1 'EV CHARGING ONLY' PARKING SIGN  
VAN AND STANDARD ACCESSIBLE STALLS #1-2  
PER CBC 11B-812.8. SEE DETAIL 6/E301
- F2 'EV CHARGING' PARKING SIGN  
AMBULATORY & STANDARD NON-ACCESSIBLE STALLS #3-40  
PER CBC 11B-812.8. SEE DETAIL 6/E301
- G1 UTILITY TRANSFORMER BOLLARD  
PER UTILITY STANDARD
- G2 PERMANENT BOLLARD (TYP.)  
SEE DETAIL 5/E302
- H1 DETECTABLE WARNING  
SEE DETAIL 5/E301
- H2 EXISTING DETECTABLE WARNING  
PROTECT IN PLACE
- J1 11"x17" PULLBOX

KEY NOTES

- 1 12" HIGH "EV CHARGING ONLY" SURFACE MARKING AT THE END OF EACH EVCS SPACE PER CBC 11B-812.9.
- 2 "NO PARKING" WORDS ON THE SURFACE OF THE ACCESS AISLE TO BE 12" MIN. IN HEIGHT AND LOCATED TO BE VISIBLE FROM THE ADJACENT VEHICULAR WAY PER CBC 11B-812.7.3.
- 3 ACCESS AISLE SHALL BE PAINTED A COLOR OTHER THAN BLUE REQUIRED FOR IDENTIFICATION FOR REGULAR ACCESS AISLES PER CBC 11B-812.7.2.
- 4 SLOPE OF WALKING SURFACES TO BE 2% MAXIMUM IN EVERY DIRECTION AT THE VAN ACCESSIBLE AND STANDARD ACCESSIBLE STALLS. ACCESS AISLE AND IN FRONT OF THE EV CHARGING STATION PER CBC 11B-812.3.
- 5 30"x48" EQUIPMENT CLEAR SPACE FOR PARALLEL APPROACH PER CBC 11B-305.
- 6 36" LEVEL EQUIPMENT CLEARANCE PER NEC 110.26.
- 7 48" LEVEL EQUIPMENT CLEARANCE PER NEC 110.26.
- 8 8' LEVEL EQUIPMENT CLEARANCE PER UTILITY STANDARDS.
- 9 CONTRACTOR SHALL POTHOLE EXACT LOCATION OF UNDERGROUND CONDUITS PRIOR TO INSTALLING EQUIPMENT AND RELOCATE EXISTING CONDUIT AS REQUIRED.
- 10 PROPOSED UNISTRUT EQUIPMENT RACK.
- 11 PROPOSED 4" THICK CONCRETE WALKWAY (5% MAX) SHALL CONNECT INTO EXISTING WALKWAY PER CBC AND AHJ REQUIREMENTS.
- 12 INSTALL VARIABLE HEIGHT CURB (6" MAX)
- 13 INSTALL WHEEL STOP (TYP.)
- 14 EXISTING ACCESS AISLE TO REMAIN. PROTECT IN PLACE.
- 15 EXISTING SIGN. PROTECT IN PLACE.

GENERAL NOTES

1. PROVIDE CLEARANCE IN FRONT OF ALL ELECTRICAL EQUIPMENT PER NEC 110.26, NEC 110.34 AND MANUFACTURER REQUIREMENTS.
2. PROVIDE REMOVABLE BOLLARDS AS REQUIRED TO MEET CLEARANCE REQUIREMENTS.
3. CONTRACTOR SHALL TRIM ANY VEGETATION THAT MAY CONFLICT WITH CONSTRUCTION OF EV FACILITY.
4. GRASS AND UNDERLYING TOPSOIL TO BE REMOVED AT EQUIPMENT PAD AND TRANSFORMER PAD AREAS.
5. CONTRACTOR SHALL EXERCISE EXTREME CAUTION IN EXCAVATING AND TRENCHING ON THIS SITE TO AVOID EXISTING DUCTS, PIPING OR CONDUITS, ETC., AND TO PREVENT HAZARDS TO PERSONNEL AND/OR DAMAGE TO EXISTING UNDERGROUND UTILITIES OR STRUCTURES. WHETHER OR NOT SHOWN AND INSTALLED BY ANY OTHER CONTRACTS, THE ENGINEER IS NOT RESPONSIBLE FOR THE EXISTING UNDERGROUND UTILITIES OR STRUCTURES WHICH ARE NOT DETAILED AND INSTALLED BY ANY OTHER CONTRACT. THE ENGINEER SHALL IMMEDIATELY NOTIFY THE ENGINEER SHOULD CONDITIONS BE DISCOVERED. THESE DRAWINGS SHALL NOT INCLUDE THE NECESSARY ELEMENTS FOR THE EXISTING UNDERGROUND UTILITIES OR STRUCTURES.
6. CALL UNDERGROUND SERVICE ALERT (USA) AT 1 (800) 422-4133 OR APPLICABLE STATE AND LOCAL DIG SAFE OR UNDERGROUND ALERT HOTLINES PRIOR TO CONSTRUCTION START.
7. SEE SINGLE LINE DIAGRAM FOR CONDUIT SIZE AND QUANTITIES.
8. HAND DIG ALL UTILITIES IN CLOSE PROXIMITY TO THE INSTALLATION OF THE ELECTRICAL EQUIPMENT TO AVOID DAMAGING ANY UTILITY LINE.
9. THE METHODS CONTAINED IN CEC/NEC ARTICLE 250 SHALL BE FOLLOWED TO COMPLY WITH GROUNDING AND BONDING OF ELECTRICAL SYSTEMS AND NON-CURRENT CARRYING CONDUCTIVE MATERIALS. ENCLOSURES OR ITEMS FORMING PART OF ANY SUCH EQUIPMENT THAT ENCLOSES OR CARRIES ELECTRICAL CONDUCTOR OR EQUIPMENT THAT IS LIKELY TO BECOME ENERGIZED. SEE CEC/NEC 250.4(A)(1) THROUGH (5) FOR FURTHER DESCRIPTION.
10. WHERE TWO OR MORE GROUND RODS ARE TO BE INSTALLED, THE MINIMUM SEPARATION SHALL BE 6" PER CEC/NEC 250.53 (A)(2) AND (3) RESISTANCE OF ELECTRODES.
11. MINIMUM CONDUIT BURIAL DEPTH SHALL BE 24".
12. ACCESS AND WORKING SPACE SHALL BE PROVIDED AND MAINTAINED ABOUT ALL ELECTRICAL EQUIPMENT TO PERMIT READY AND SAFE OPERATION AND MAINTENANCE OF SUCH EQUIPMENT PER CEC/NEC 110.26.
13. CONDUIT BODIES, JUNCTION BOXES AND PULLBOXES SHALL BE USED AS NEEDED TO MAINTAIN LESS THAN 360° OF CONDUIT BENDS BETWEEN PULL POINTS.


DEVELOPER:



ELECTRICAL ENGINEER:



ENGINEERS STAMP:

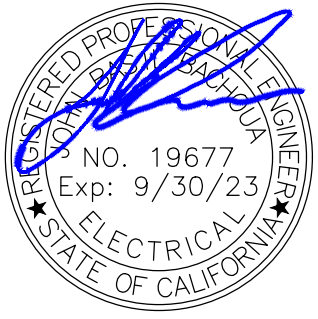

DATE SIGNED: 06/02/23

PROJECT NUMBER: 2314-03

DRAWN BY: RF

CHECKED BY: JB

REVISIONS

REV	DATE	DESCRIPTION	BY
0	05/12/23	IFP PLAN PACKAGE	JB
1	06/02/23	PLAN CHECK #1	JB

SITE ADDRESS

MARINA DEL REY LOT 5


DEPARTMENT OF  
REGIONAL PLANNING APPROVED

SHEET TITLE

ELECTRICAL  
LAYOUT PLAN

SHEET NUMBER

E102

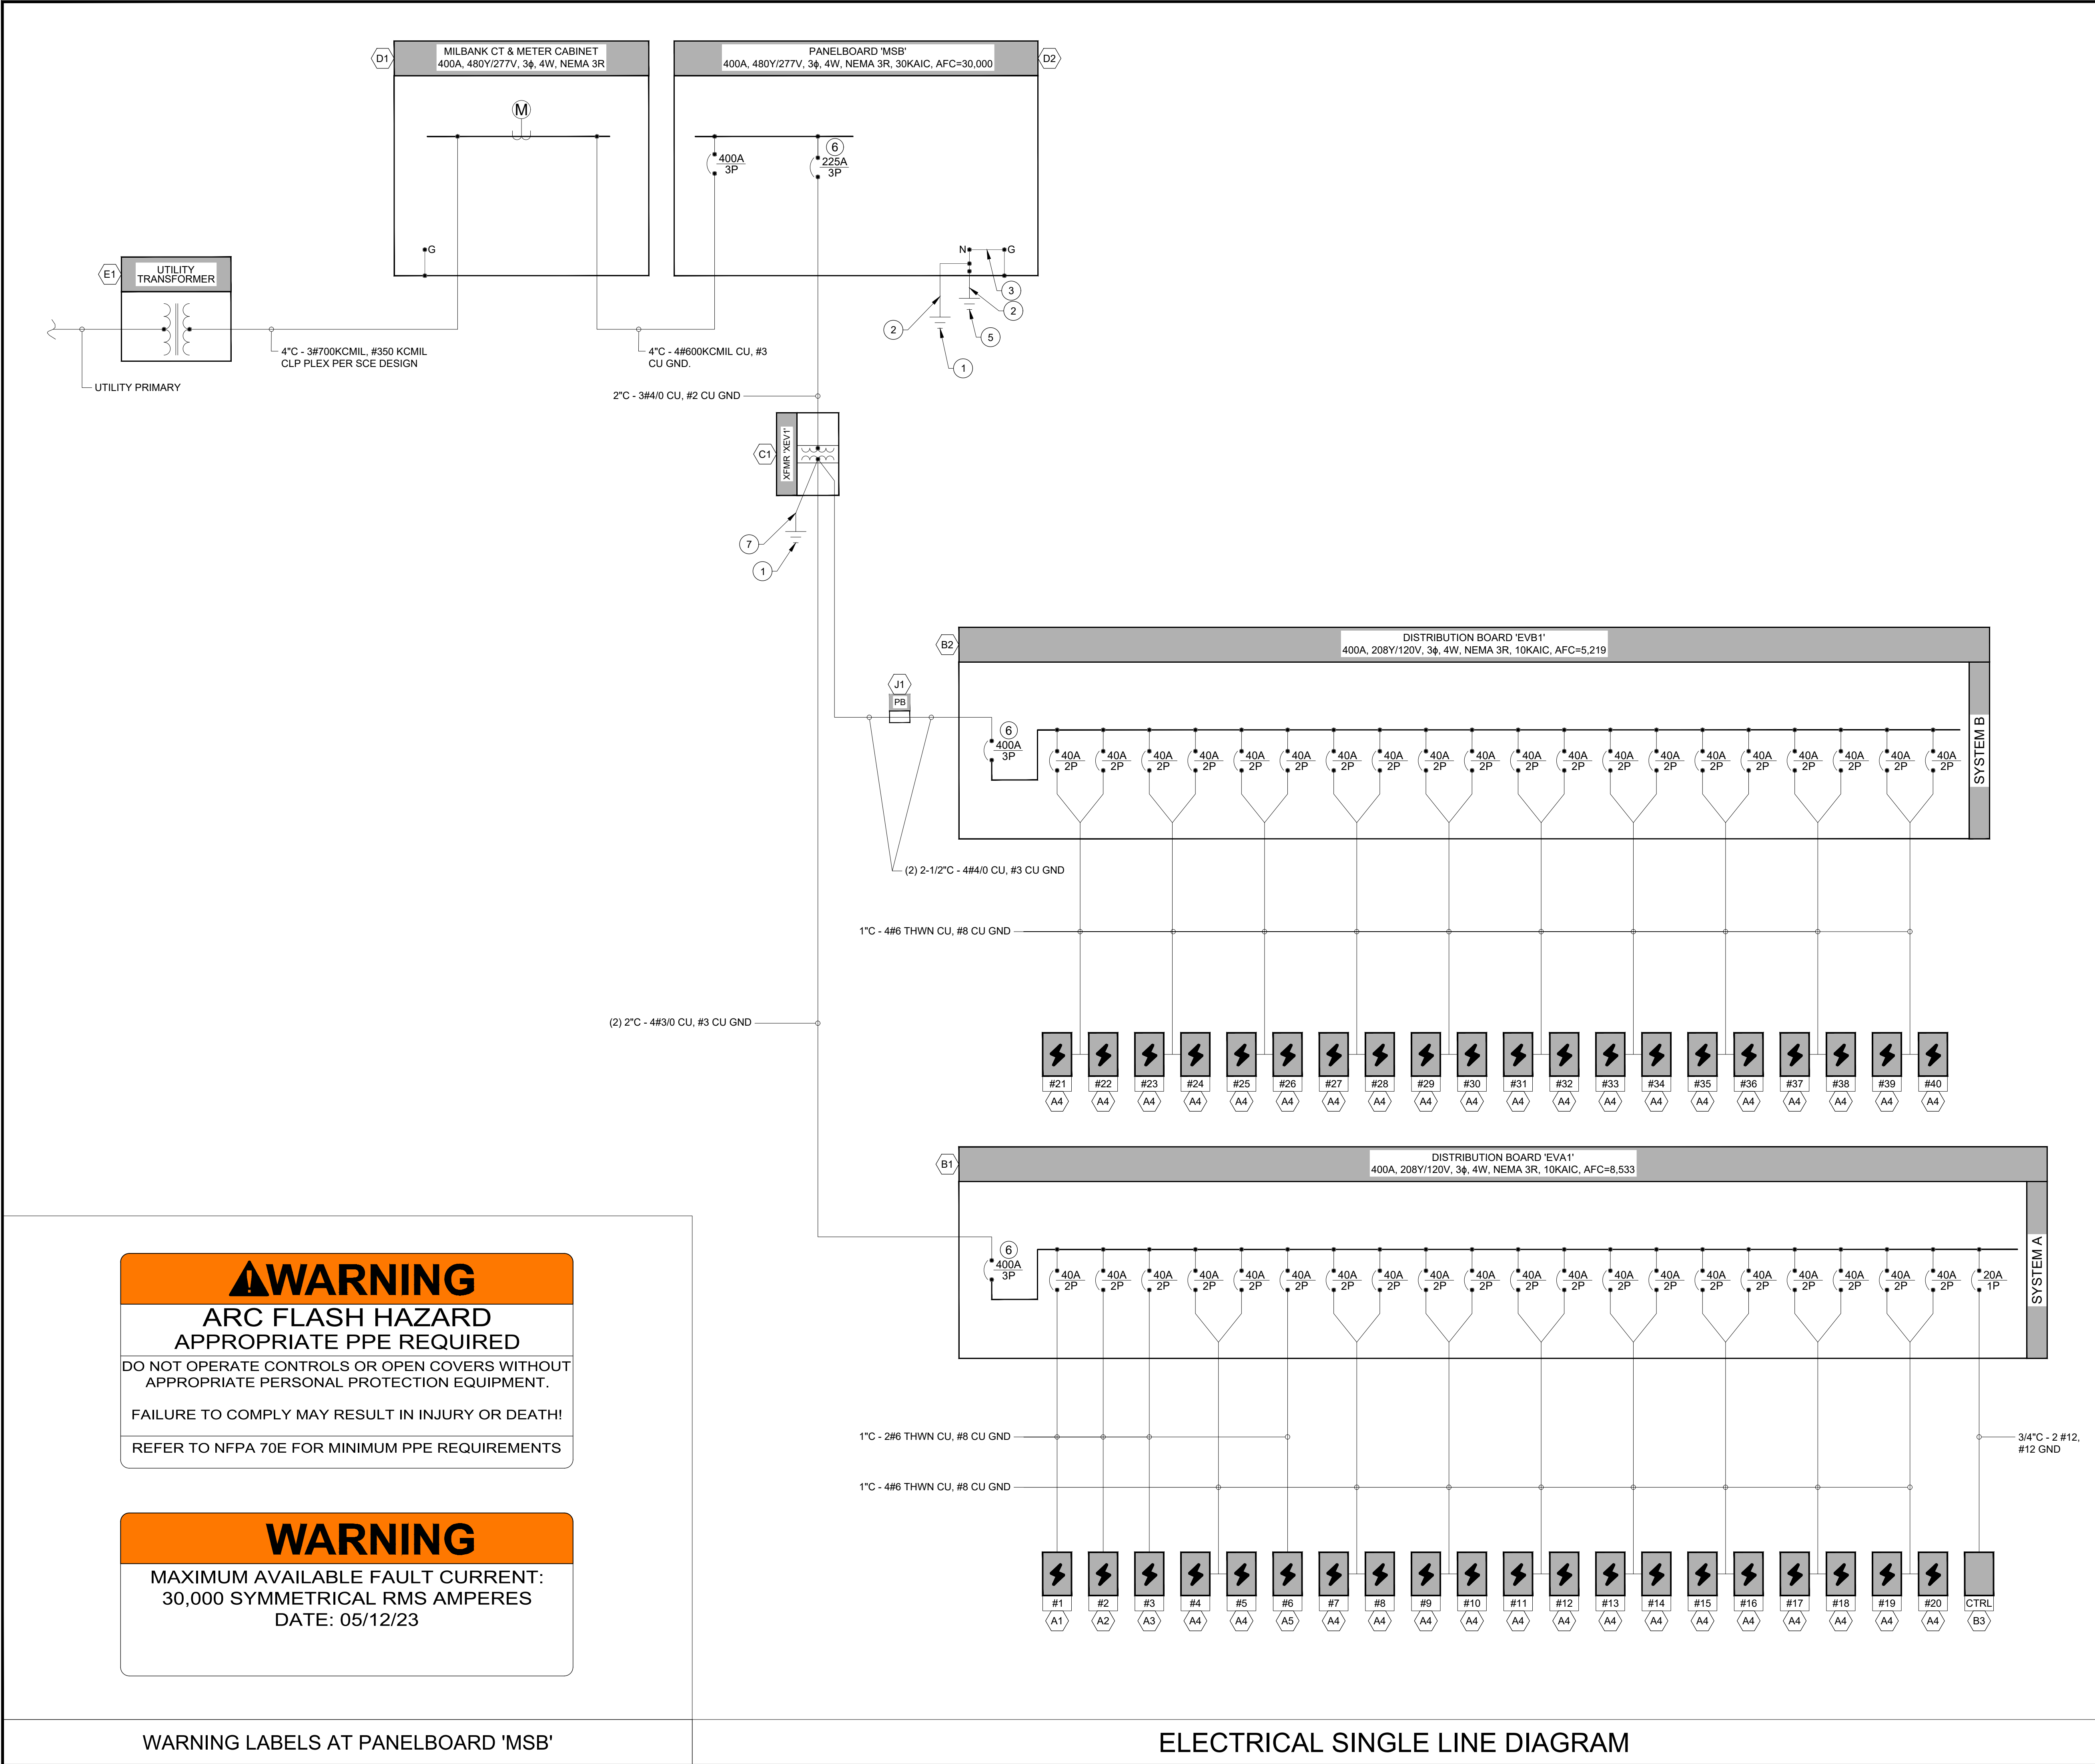

### EQUIPMENT SCHEDULE

A1	7.7KW EV CHARGER VAN ACCESSIBLE STALL #1 WEBASTO MODEL# TURBODX 32A (SINGLE PEDESTAL)
A2	7.7KW EV CHARGER STANDARD ACCESSIBLE STALL #2 WEBASTO MODEL# TURBODX 32A (SINGLE PEDESTAL)
A3	7.7KW EV CHARGER AMBULATORY STALL #3 WEBASTO MODEL# TURBODX 32A (SINGLE PEDESTAL)
A4	7.7KW EV CHARGER STANDARD STALLS #4-5 & 7-40 WEBASTO MODEL# TURBODX 32A (DUAL PEDESTAL)
A5	7.7KW EV CHARGER STANDARD STALL #6 WEBASTO MODEL# TURBODX 32A (SINGLE PEDESTAL)
B1	SYSTEM A DISTRIBUTION BOARD 'EVA1' (STALLS #1-20) 400A, 208Y/120V, 3φ, 4W, NEMA 3R, 10KAIC
B2	SYSTEM B DISTRIBUTION BOARD 'EVB1' (STALLS #21-40) 400A, 208Y/120V, 3φ, 4W, NEMA 3R, 10KAIC
B3	LOAD MANAGEMENT CONTROLLER 'LMC' NEXUS CORE ENCLOSURE
C1	TRANSFORMER 'XEV1' HAMMOND POWER SOLUTIONS MODEL #DH4-N3R 150KVA, 3φ, NEMA 3R
D1	MILBANK CT AND METER CABINET 400A, 480Y/277V, 3φ, 4W, NEMA 3R
D2	PANELBOARD 'MSB' 400A, 480Y/277V, 3φ, 4W, NEMA 3R, 30KAIC
E1	UTILITY TRANSFORMER PAD PER SCE STANDARD (75-500KVA, 3φ, 72"X94" CONCRETE PAD)
J1	11"x17" PULLBOX

### KEY NOTES

- GROUNDING ELECTRODE 5/8"x8'-0" COPPER CLAD GROUND ROD. INSTALLATION PER NEC 250.52 (A)(5) AND 250.68. THERE SHALL BE TWO GROUND RODS SEPARATED BY SIX OR MORE FEET OR PROVIDE A CERTIFIED TEST SHOWING THAT THE RESISTANCE TO GROUND IS 25 OHMS OR LESS.
- #1/0 AWG BARE CU GROUNDING ELECTRODE CONDUCTOR PER CEC 250.66(B).
- #1/0 AWG BARE CU MAIN BONDING JUMPER PER CEC 250.24(A)(4), 250.28(C), 250.8(A)(7), 250.102(C)(1).
- NOT USED.
- CONCRETE ENCASED ELECTRODE PER CEC 250.52(A)(3)(1) OR (2).
- DISCONNECTING MEANS SHALL BE LOCKABLE PER NEC 625.42.
- #2 AWG BARE CU GROUNDING ELECTRODE CONDUCTOR PER CEC 250.66(B).

### GENERAL NOTES

- ALL CONDUIT AND WIRING BY CONTRACTOR UNLESS NOTED OTHERWISE.
- ALL CONDUCTORS ARE COPPER (CU) UNLESS NOTED OTHERWISE.
- PROVIDE 12" MIN. SEPARATION BETWEEN COMMUNICATION & POWER CONDUITS IN UNDERGROUND TRENCH INSTALLATION.
- PROVIDE FULLY RATED BREAKERS THROUGHOUT.
- REFER TO UTILITY DESIGN DOCUMENT FOR DETAILS ON UTILITY TRANSFORMER AND CONDUIT REQUIREMENTS.
- MAIN SHALL BE 100% RATED.

### LOAD LIMITIN

LOAD LIMITING FUNCTION OF ALL CHARGERS SHALL BE CONFIGURED AS NEEDED SUCH THAT THE TOTAL LOAD DRAWN BY THE PROPOSED CHARGERS DOES NOT EXCEED THE MAIN BREAKER RATING FOR EACH PANEL OR UTILITY TRANSFORMER CAPACITY.

### COUNTY OF LOS ANGELES NOTES

- ALL ELECTRICAL EQUIPMENT SHALL BE LABELED, LISTED OR CERTIFIED BY A NATIONALLY RECOGNIZED TESTING LABORATORY ACCREDITED BY THE UNITED STATES OCCUPATIONAL SAFETY ADMINISTRATION.
- EQUIPMENT GROUND CONDUCTORS SMALLER THAN 6 AWG SHALL BE PROTECTED FROM PHYSICAL DAMAGE BY AN IDENTIFIED RACEWAY OR CABLE ARMOR UNLESS INSTALLED WITH HOLLOW SPACES OF THE FRAMING MEMBERS OF BUILDINGS OR STRUCTURES AND WHERE NOT SUBJECT TO PHYSICAL DAMAGE. ART. 250.1(C), ART. 690.46.

DEPARTMENT OF  
**REGIONAL PLANNING APPROVED**

**REVISIONS**

REV	DATE	DESCRIPTION	BY
0	05/12/23	IFP PLAN PACKAGE	JB
1	06/02/23	PLAN CHECK #1	JB

**SITE ADDRESS**

MARINA DEL REY LOT 5

**SHEET TITLE**

**ELECTRICAL  
SINGLE LINE  
DIAGRAM**

**SHEET NUMBER**

**E201**

LOAD CALCULATIONS

LOAD CALCULATION - MSB

208Y/120V, 800A, 3PH, 4W

	Ø A	Ø B	Ø C
PANEL EV1	43,264	46,592	43,264
PANEL EV2	43,264	46,592	43,264
Total Connected Load (VA):	86,528	93,184	86,528
Total Code Load (Amps):	313	337	313

VOLTAGE DROP CALCULATIONS

FROM	TO	I (A)	V <sub>NOM</sub>	AC/DC	Ø	WIRE MATERIAL	AWG	# IN PARALLEL	WIRE MAX TEMP (°C)	Ω/kft	1-WAY DIST (FT)	V.D.
'CT & METER'	'MSB'	400	480	AC	3	CU	600	1	87-95	0.019419	5	0.01%
'MSB'	XFMR 'XEV1'	400	480	AC	3	CU	4/0	1	87-95	0.054512	10	0.08%
XFMR 'XEV1'	'EVA1'	400	208	AC	3	CU	3/0	2	87-95	0.069403	10	0.12%
XFMR 'XEV1'	'EVB1'	400	208	AC	3	CU	4/0	2	87-95	0.054512	310	2.81%
'EVA1'	EV CHARGER #19-20	32	208	AC	3	CU	6	1	87-95	0.444108	215	2.54%
'EVB1'	EV CHARGER #39-40	32	208	AC	3	CU	6	1	87-95	0.444108	85	1.01%

SHORT CIRCUIT CALCULATIONS

3Ø SHORT CIRCUIT CALCULATIONS  
(FEEDER LENGTHS SHOWN IN THIS CALCULATION SHALL NOT BE USED FOR BID PURPOSES OF DETERMINING ACTUAL FEEDER LENGTHS)  
THE FOLLOWING CALCULATIONS ARE BASED ON POINT TO POINT METHOD

$$I_{CONDUCTOR} = \sqrt{3 \times I_L \times I_{SC}} \times [C \times N \times V_L]$$
$$M = 1 + [1 + f]$$
$$I_{SC} = I_{SC} \times M$$

UTILITY FAULT CONTRIBUTION IS TAKEN FROM SCE ELECTRIC SERVICE REQUIREMENTS

FAULT LOCATION	FED FROM	KVA <sub>XFMR</sub>	E <sub>(volts)</sub>	%Z	FEEDER	CONDUIT TYPE	FEEDER SIZE	# OF PARALLEL RUNS (N)	INSULATION VOLTAGE	L <sub>(ft)</sub>	C	f	M	I <sub>SC</sub>	MOTOR CONT. (AMPS)	I <sub>SC, TOTAL</sub>	EQUIPMENT MIN. KAIC
CT & METER CABINET	UTILITY		480											30,000		30,000	30
MSB	CT & METER CABINET		480		CU	M	600	1	600	5	22965	0.024	0.977	29,309		29,309	30
XFMR 'XEV1'-PRI	MSB		480		CU	NM	4/0	1	600	10	16673	0.063	0.940	27,561		27,561	30
XFMR 'XEV1'-SEC	XFMR 'XEV1'-PRI	150	208	1.20								1.833	0.353	22,450		22,450	
PANEL 'EVA1'	XFMR 'XEV1'-SEC		208		CU	NM	3/0	2	600	10	13923	0.067	0.937	21,037		21,037	25
PANEL 'EVB1'	XFMR 'XEV1'-SEC		208		CU	NM	4/0	2	600	310	16673	1.738	0.365	8,200		8,200	10

'EVA1' DISTRIBUTION PANEL SCHEDULE


Panel:	EVA1	Mains:	400A	Voltage:	208Y/120V, 3ø, 4W, 400A	
Mounting:	SURFACE	Type:	BOLT-ON	Min. A.I.C.:	SERIES RATED	
Use and/or Area Served	C/B	Cir. No.	Load Ø A Ø B Ø C	Cir. No.	C/B	Use and/or Area Served
EV-1		1	3328 3328		40	EV-11
--		3	3328 3328		2	--
EV-2		5	3328 3328		4	EV-12
--		7	3328 3328		6	--
EV-3		9	3328 3328		8	EV-13
--		11	3328 3328		10	--
EV-4		13	3328 3328		12	EV-14
--		15	3328 3328		14	--
EV-5		17	3328 3328		16	EV-15
--		19	3328 3328		18	--
EV-6		21	3328 3328		20	EV-16
--		23	3328 3328		22	--
EV-7		25	3328 3328		24	EV-17
--		27	3328 3328		26	--
EV-8		29	3328 3328		28	EV-18
--		31	3328 3328		30	--
EV-9		33	3328 3328		32	EV-19
--		35	3328 3328		34	--
SPACE		37	3328 3328		36	EV-20
EV-10		39	3328 3328		38	--
--		41	3328 3328		40	POWER MANAGEMENT CONTROLLER
Total Connected Load (VA):			43264 46592 43264	NOTES:		
Total Code Load (VA):			43264 46592 43264			
Total Code Load (Amps):			361 389 361			

'EVB1' DISTRIBUTION PANEL SCHEDULE

Panel:	EVB1	Mains:	400A	Voltage:	208Y/120V, 3ø, 4W, 400A	
Mounting:	SURFACE	Type:	BOLT-ON	Min. A.I.C.:	SERIES RATED	
Use and/or Area Served	C/B	Cir. No.	Load Ø A Ø B Ø C	Cir. No.	C/B	Use and/or Area Served
EV-21		1	3328 3328		40	EV-31
--		3	3328 3328		2	--
EV-22		5	3328 3328		4	EV-32
--		7	3328 3328		6	--
EV-23		9	3328 3328		8	EV-33
--		11	3328 3328		10	--
EV-24		13	3328 3328		12	EV-34
--		15	3328 3328		14	--
EV-25		17	3328 3328		16	EV-35
--		19	3328 3328		18	--
EV-26		21	3328 3328		20	EV-36
--		23	3328 3328		22	--
EV-27		25	3328 3328		24	EV-37
--		27	3328 3328		26	--
EV-28		29	3328 3328		28	EV-38
--		31	3328 3328		30	--
EV-29		33	3328 3328		32	EV-39
--		35	3328 3328		34	--
SPACE		37	3328 3328		36	EV-40
EV-30		39	3328 3328		38	--
--		41	3328 3328		40	SPACE
Total Connected Load (VA):			43264 46592 43264	NOTES:		
Total Code Load (VA):			43264 46592 43264			
Total Code Load (Amps):			361 389 361			


DEPARTMENT OF REGIONAL PLANNING APPROVED

DEVELOPER:




392 FIRST STREET  
LOS ALTOS, CA 94022  
P. 650.469.3392

ELECTRICAL ENGINEER:



NAZARENE ENGINEERING  
2514 JAMACHA RD. #502-182  
EL CAJON, CA 92019  
619.333.6703  
WWW.NAZENGINEERING.COM

ENGINEERS STAMP:



DATE SIGNED: 06/02/23

PROJECT NUMBER: 2314-03

DRAWN BY: RF

CHECKED BY: JB

REVISIONS

REV	DATE	DESCRIPTION	BY
0	05/12/23	IFP PLAN PACKAGE	JB
1	06/02/23	PLAN CHECK #1	JB

SITE ADDRESS


MARINA DEL REY LOT 5

SHEET TITLE


CALCULATIONS AND PANEL SCHEDULES

SHEET NUMBER

E202

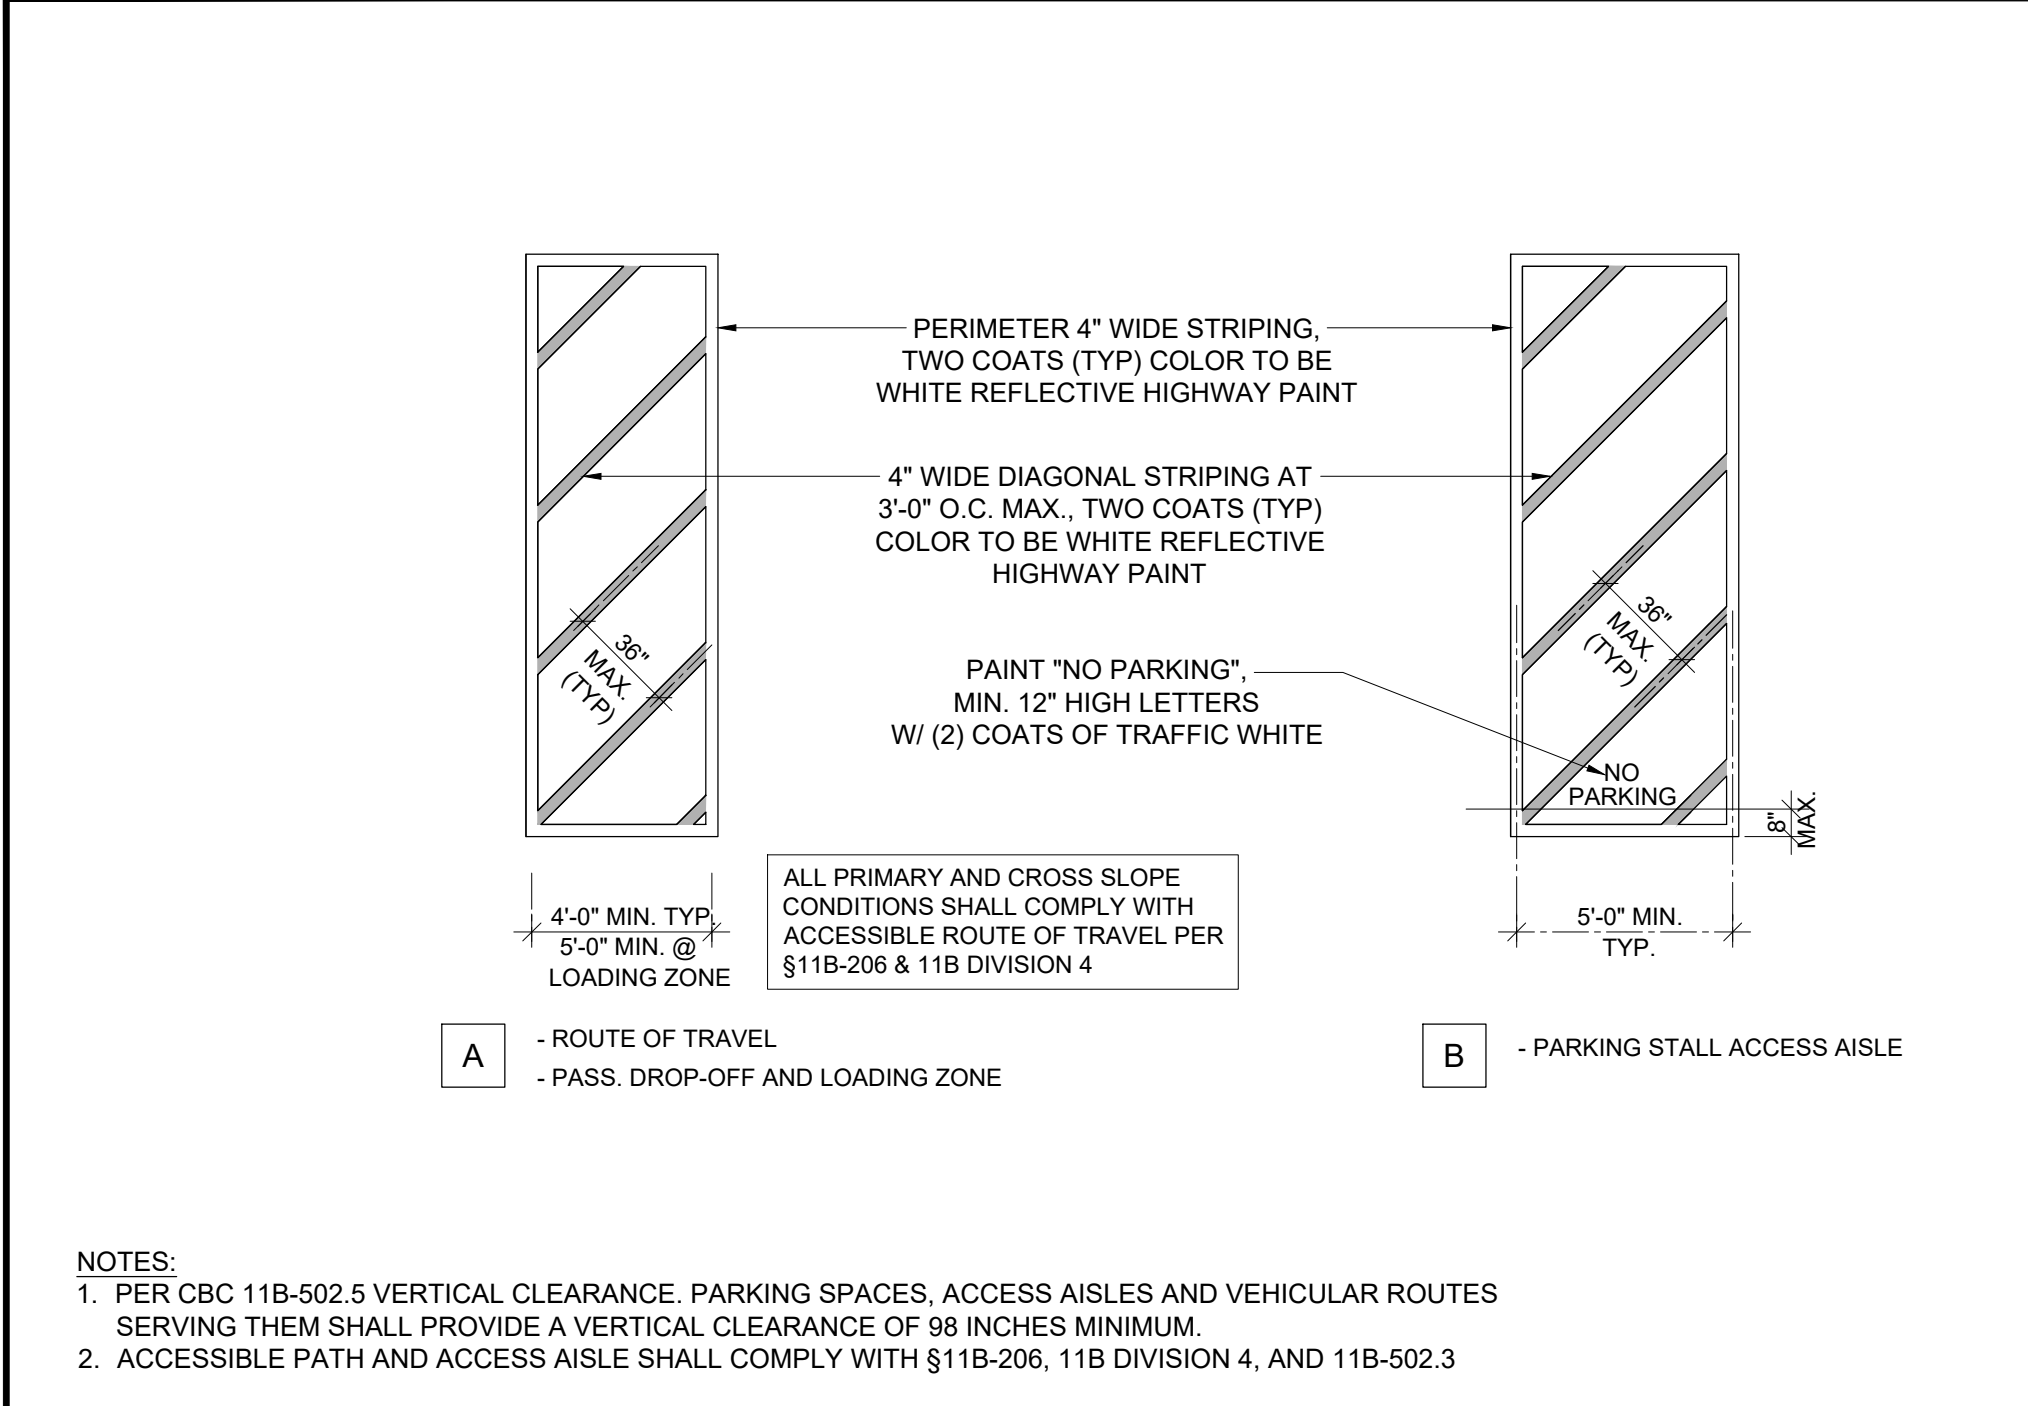

7 ACCESSIBLE PATH AND AND PARKING STALL AISLE STRIPING DETAIL NOT TO SCALE

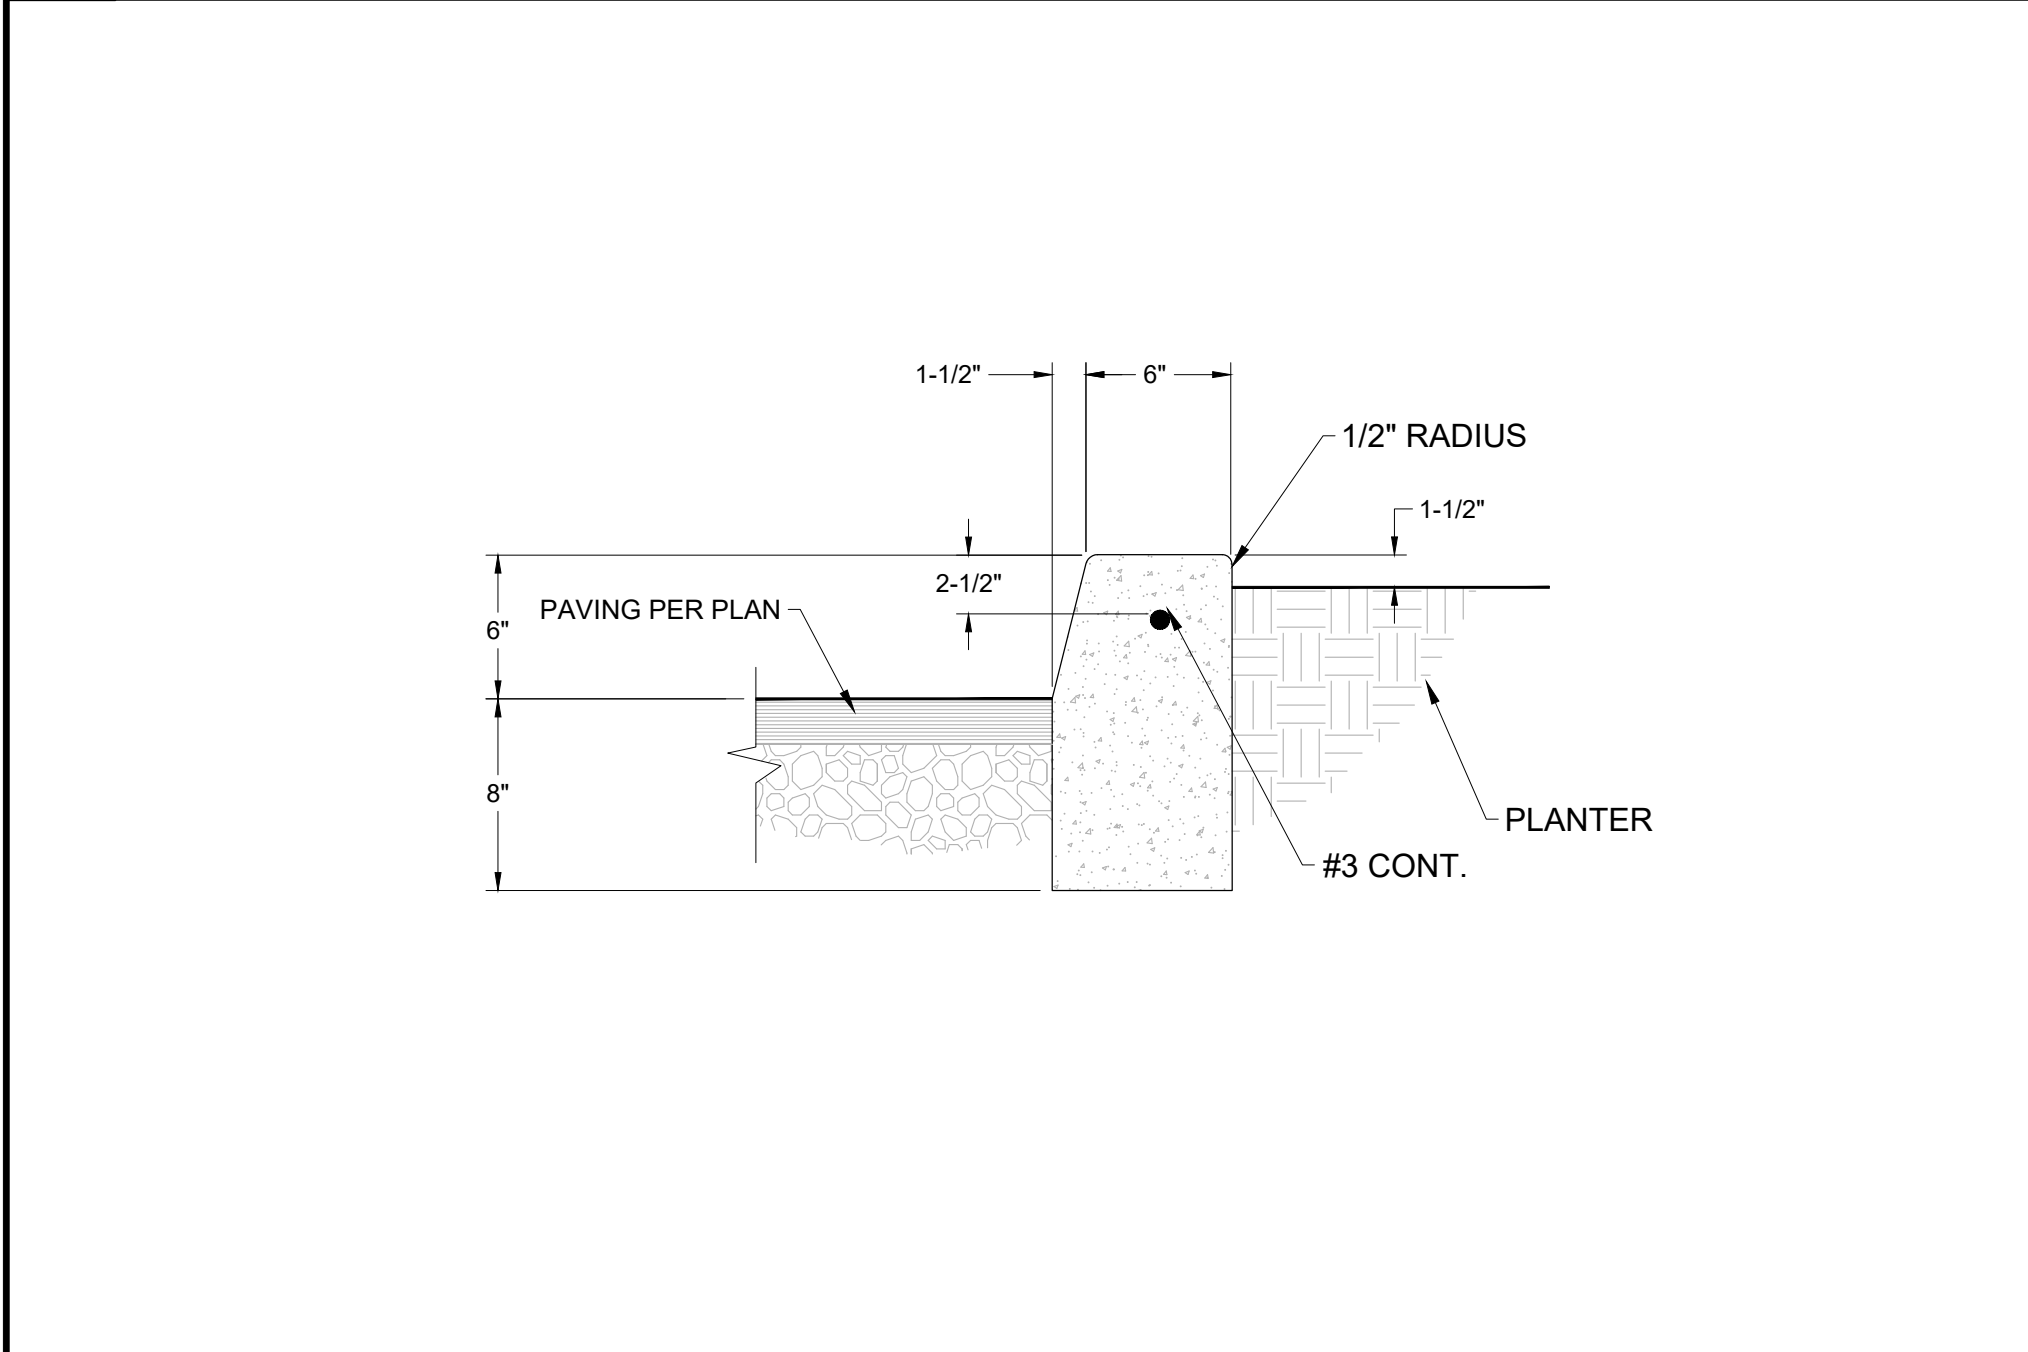


8 6" CURB DETAIL NOT TO SCALE




9 NOT USED




4 ELECTRIC VEHICLE ONLY SURFACE STENCIL DETAIL NOT TO SCALE

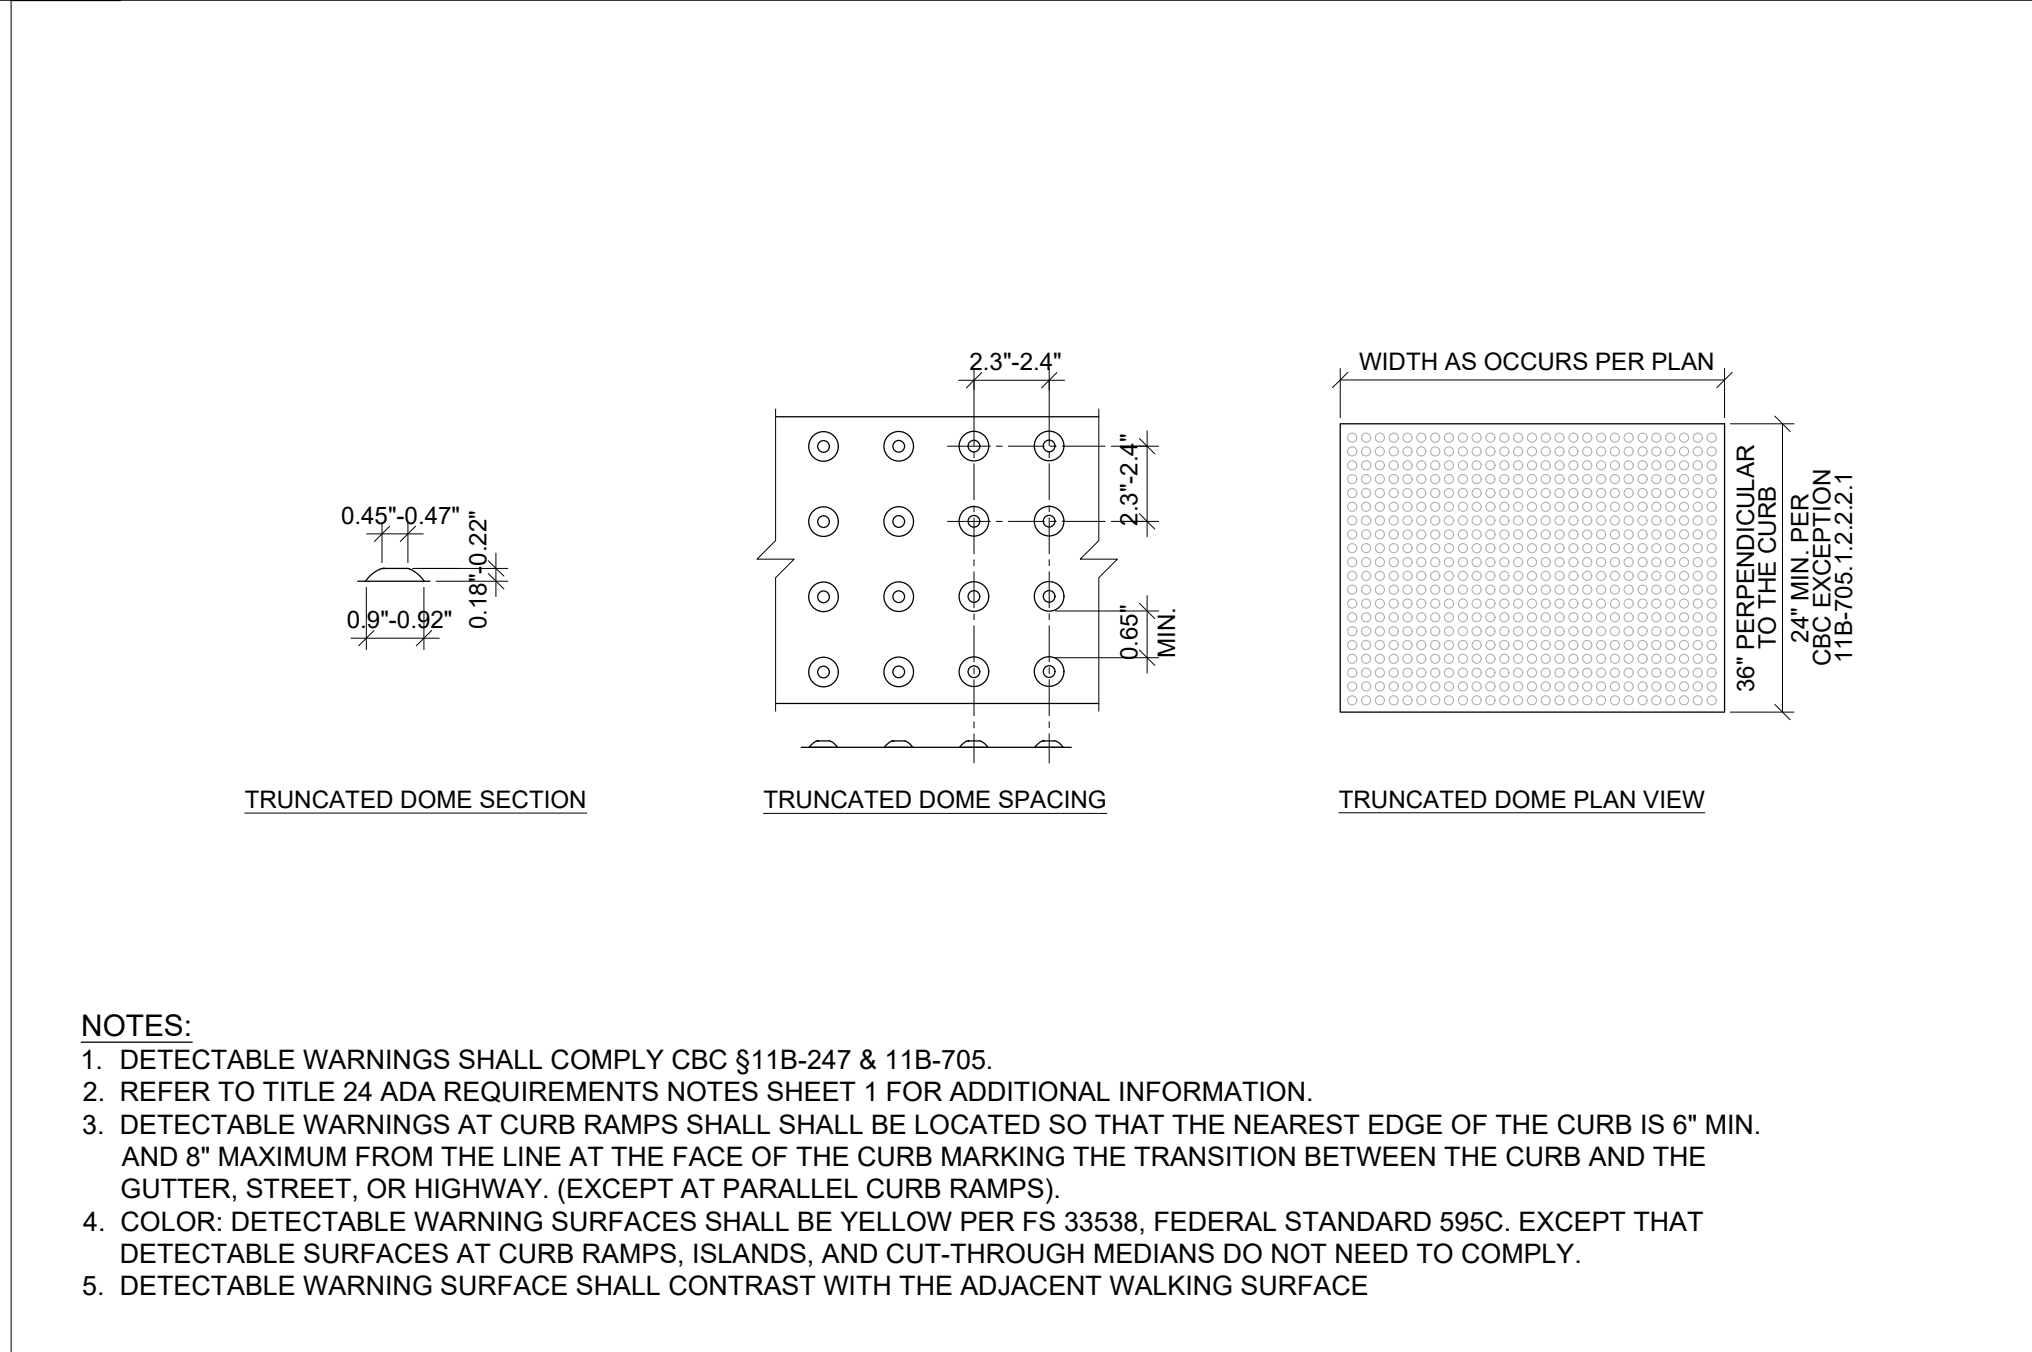


5 TRUNCATED DOME DETECTABLE WARNING DETAIL NOT TO SCALE

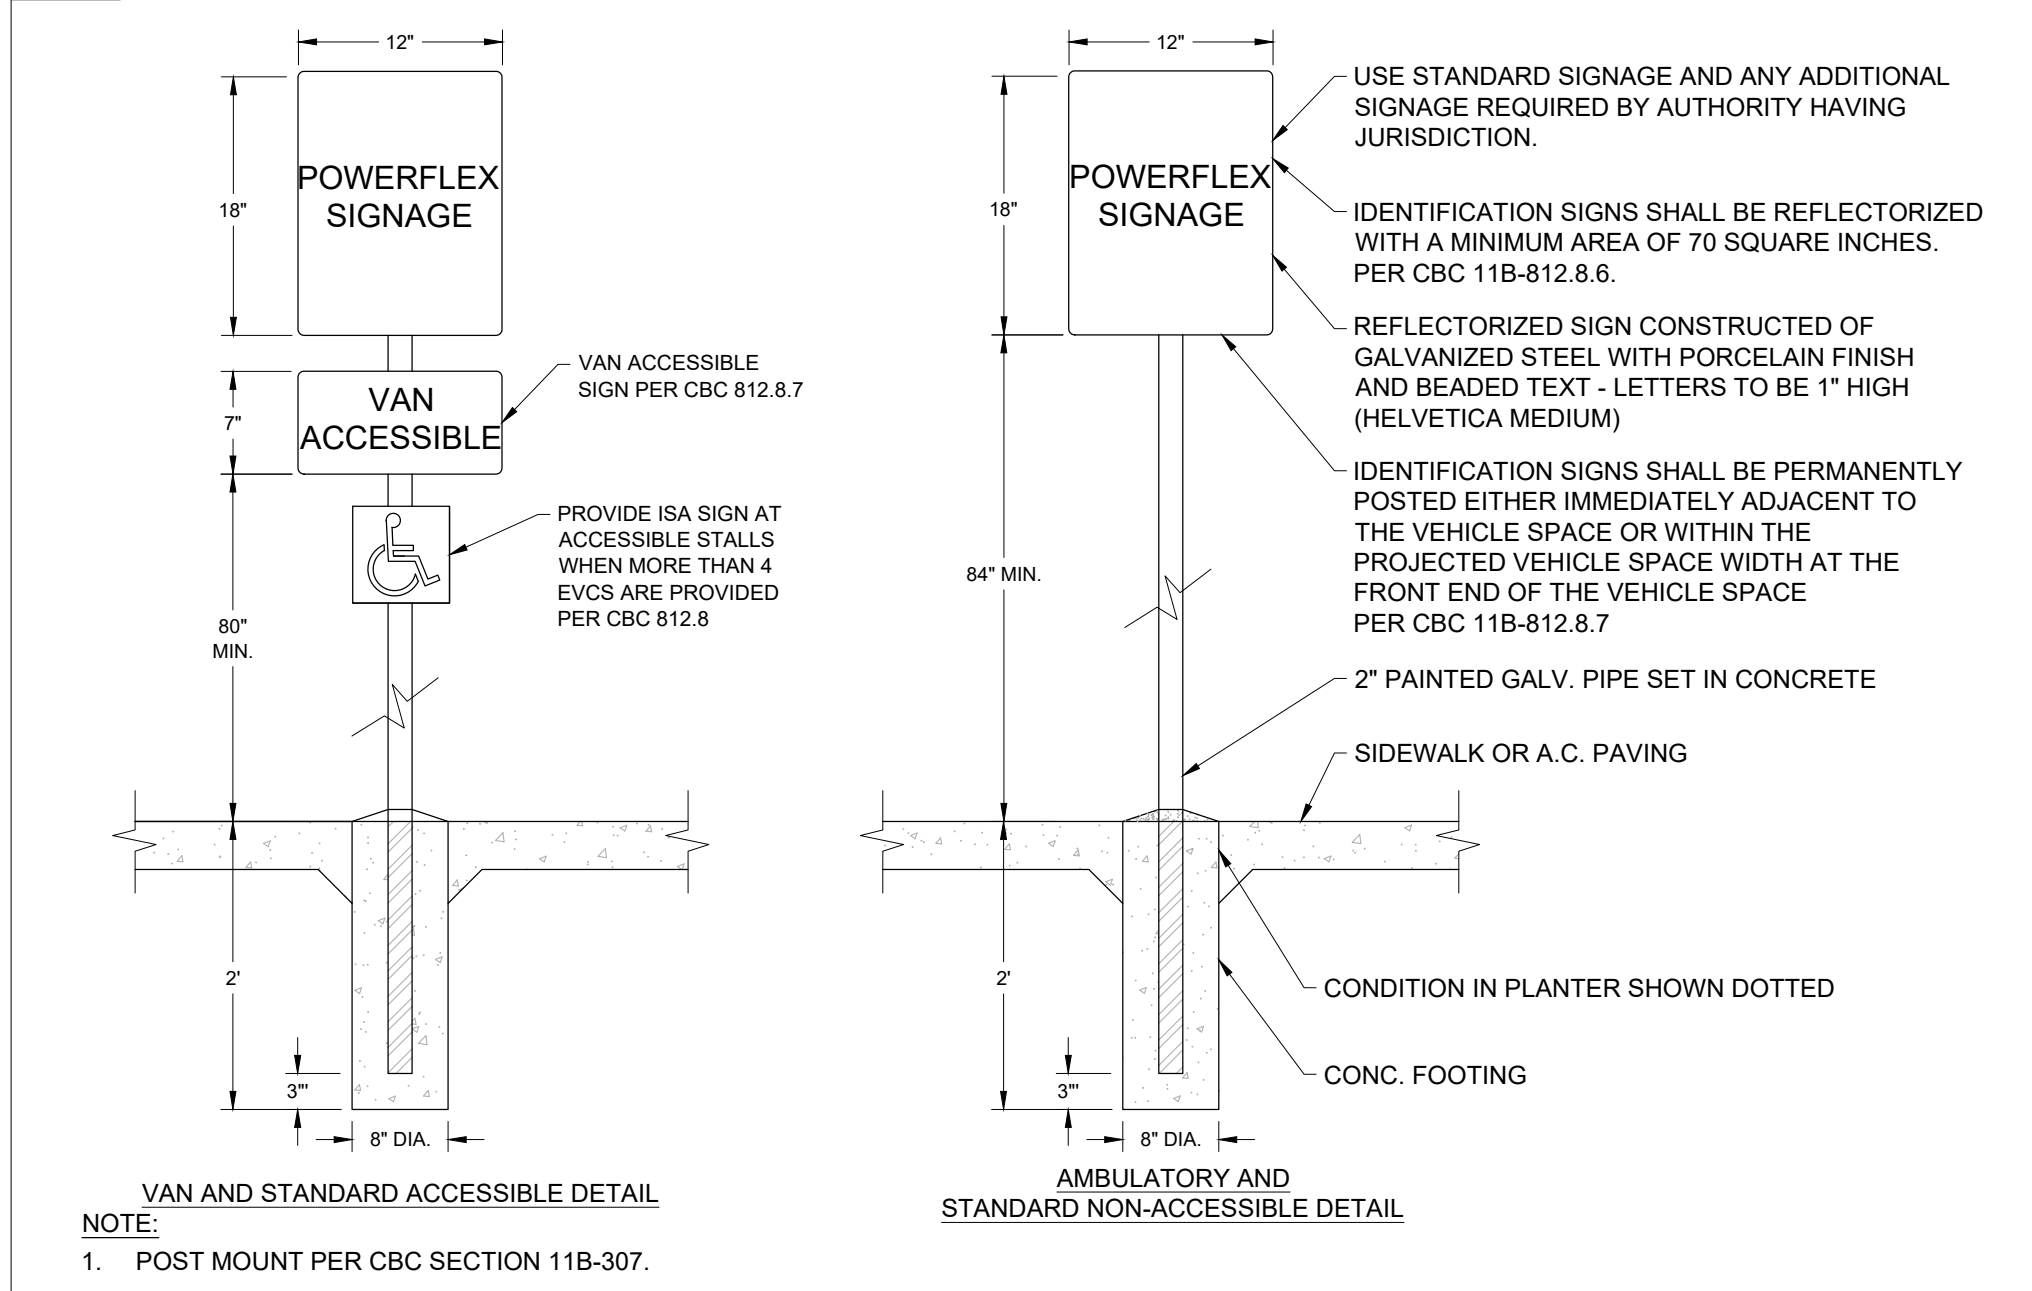


6 VAN ACCESSIBLE AND STANDARD PARKING EV SIGN DETAIL NOT TO SCALE

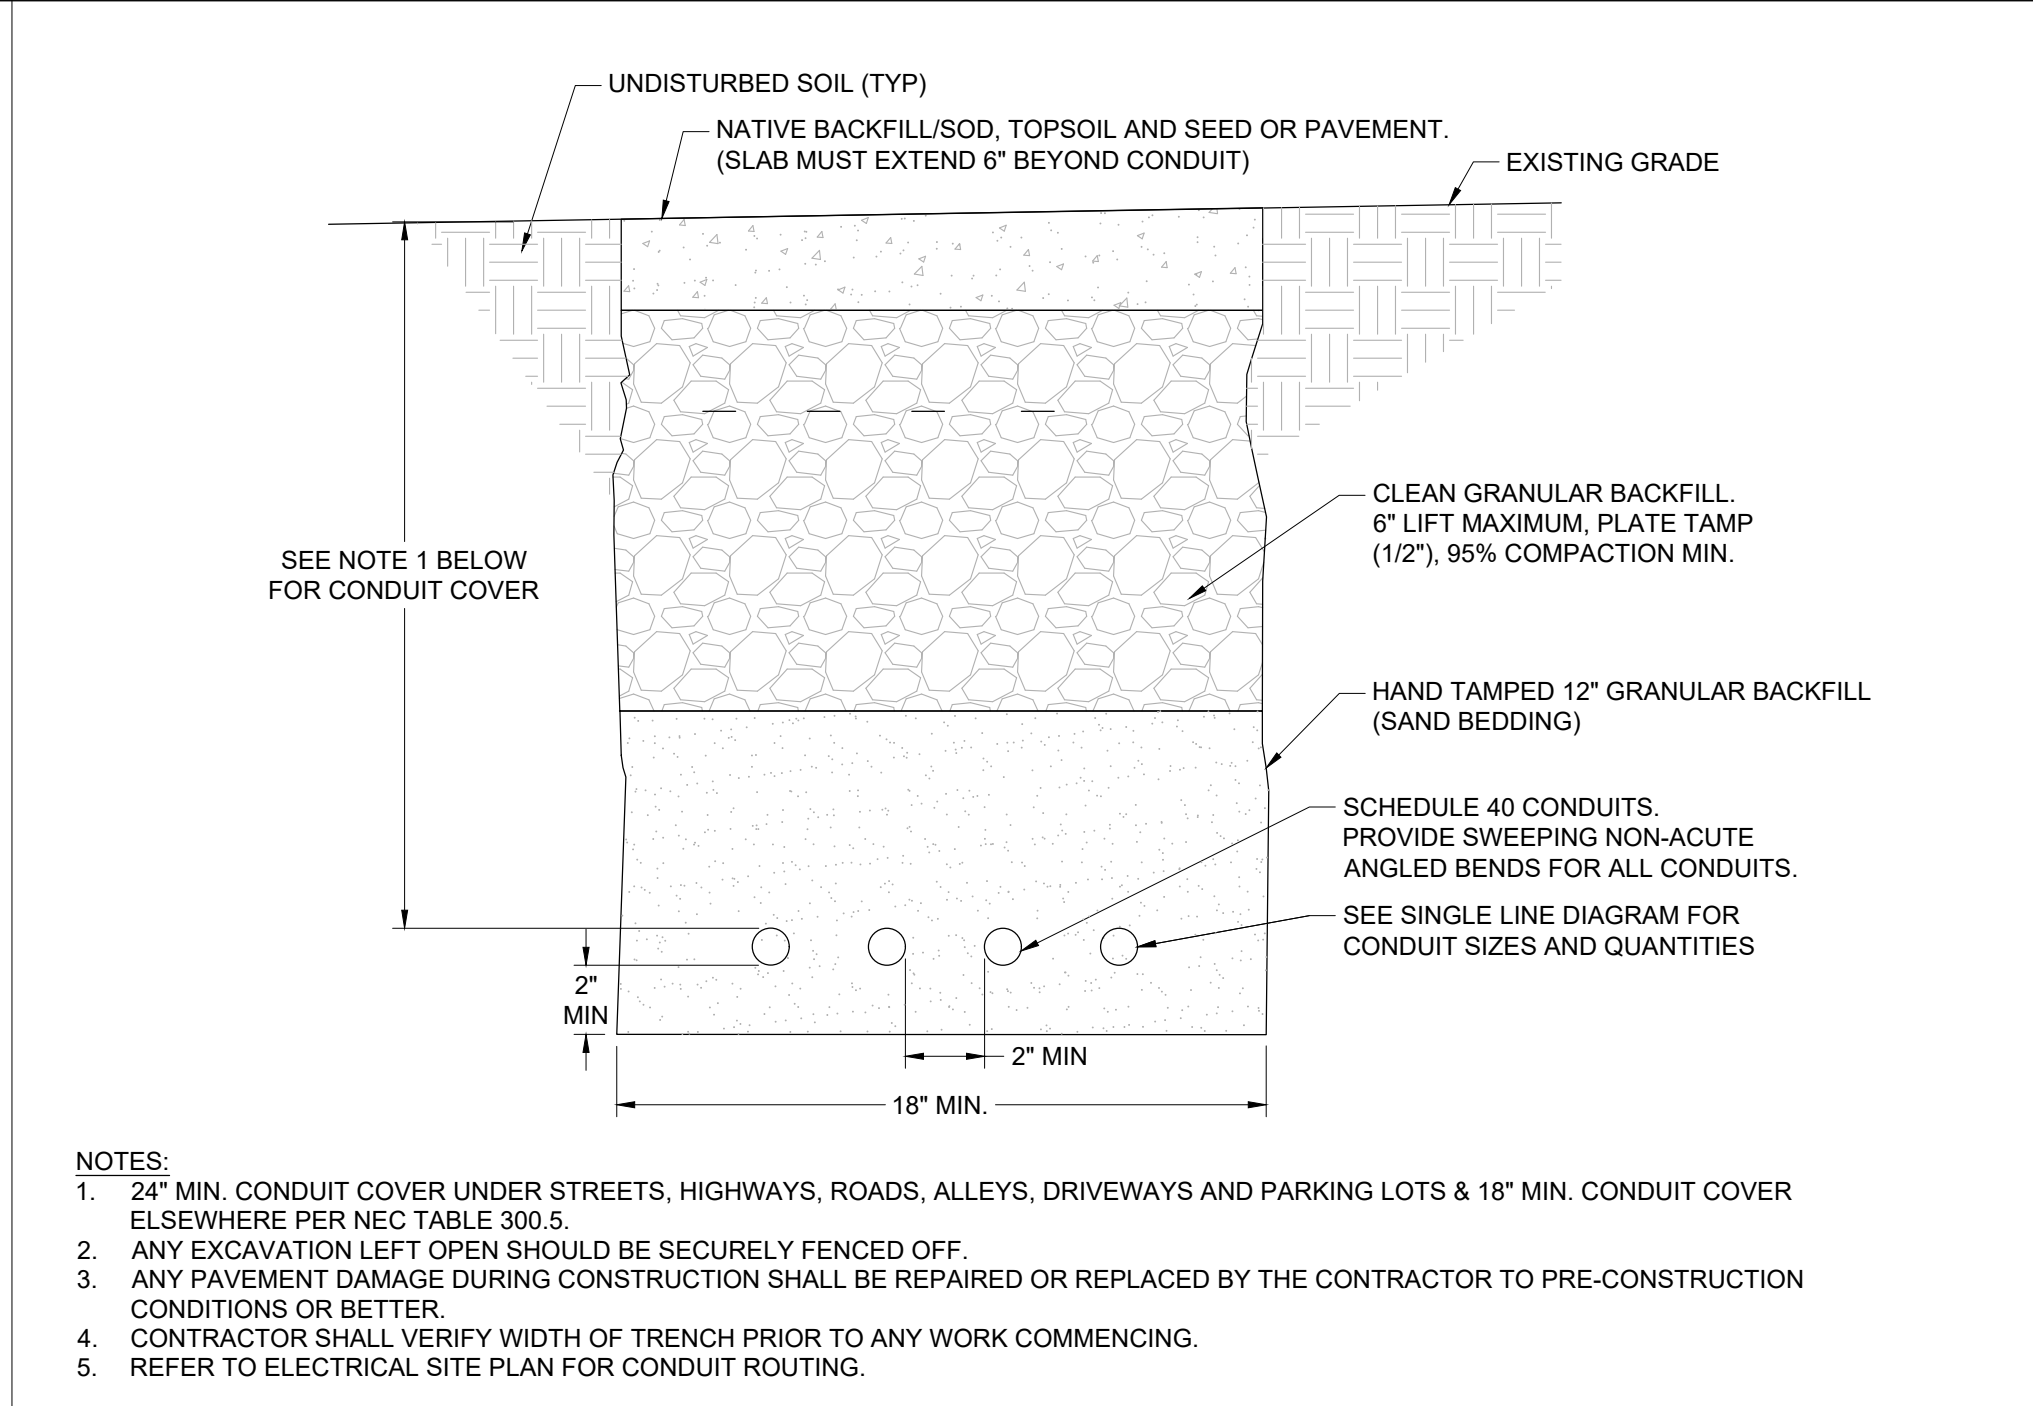

1 TRENCH DETAIL NOT TO SCALE

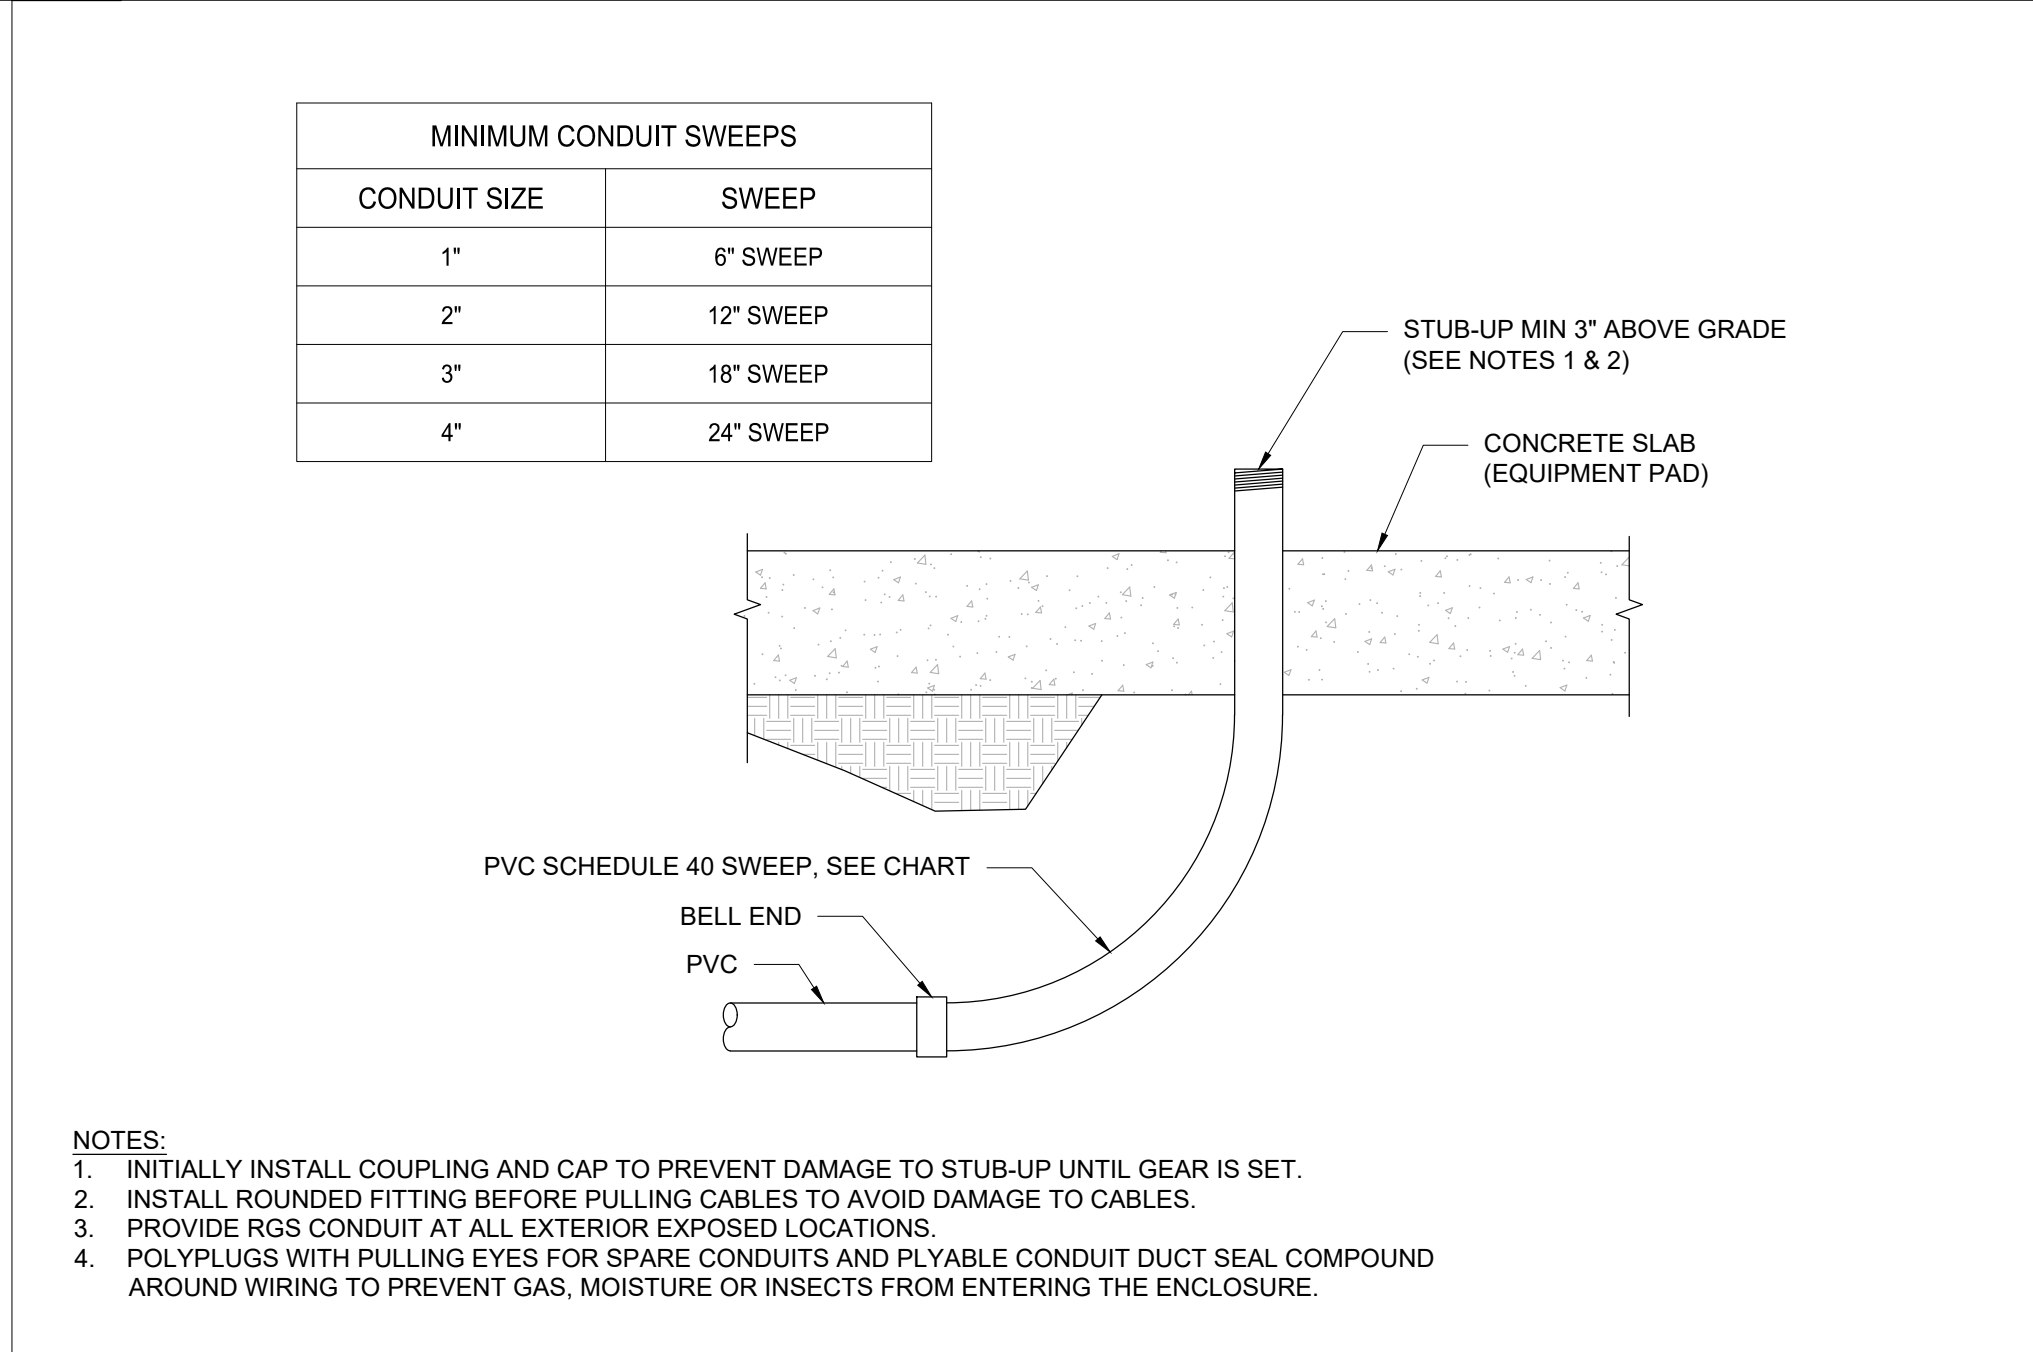

2 EQUIPMENT PAD CONDUIT STUB-UP DETAIL NOT TO SCALE

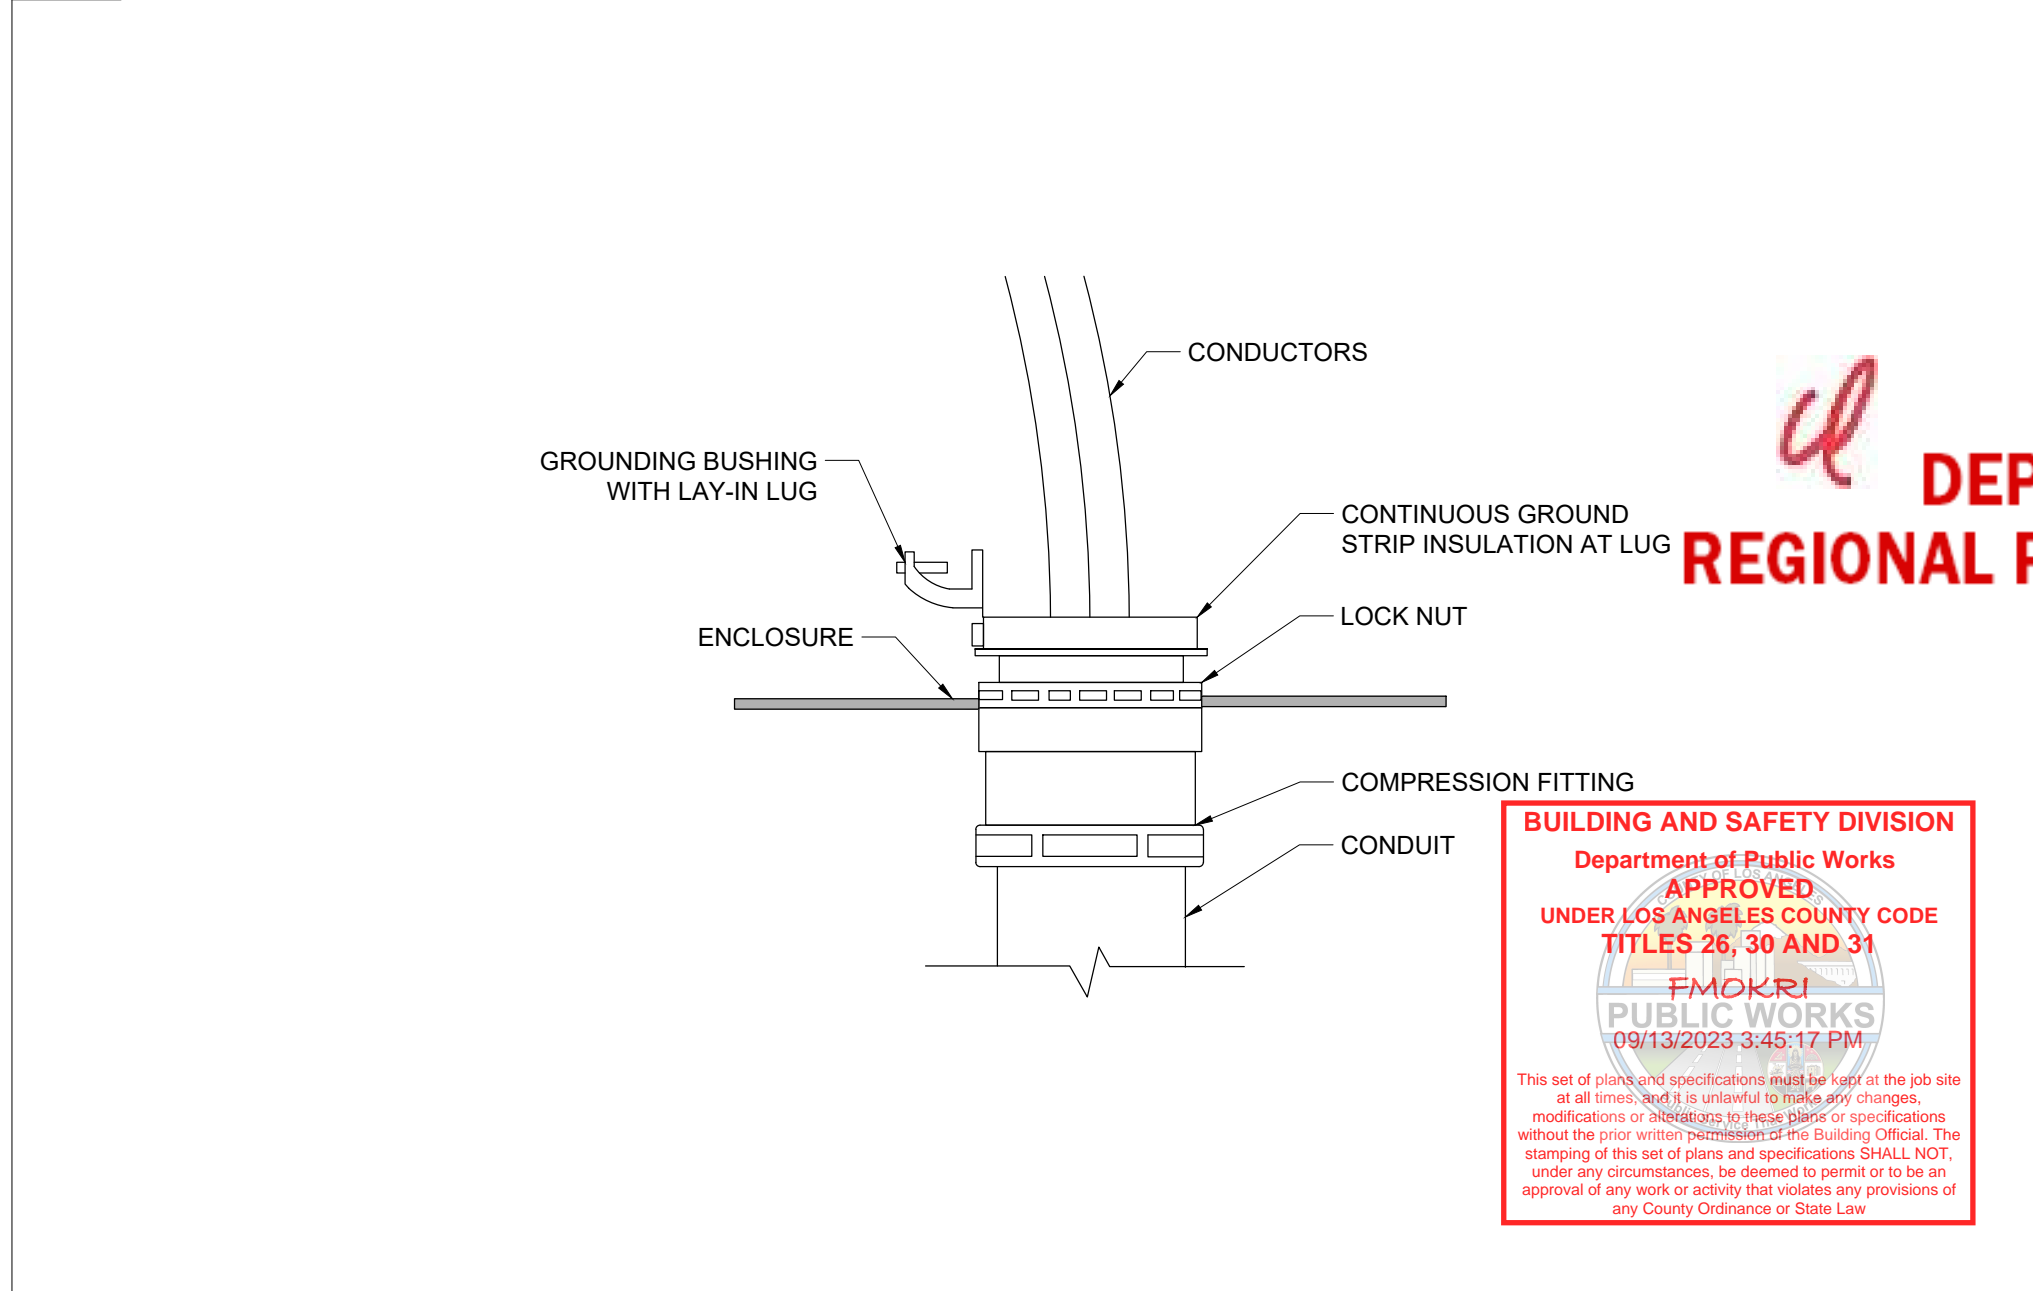

3 EQUIPMENT GROUNDING DETAIL NOT TO SCALE

DEVELOPER:

**powerflex**  
EDF renewables

392 FIRST STREET  
LOS ALTOS, CA 94022  
P. 650.469.3392

ELECTRICAL ENGINEER:

**nazarene engineering**

NAZARENE ENGINEERING  
2514 JAMACHA RD. #502-182  
EL CAJON, CA 92019  
619.333.6703  
WWW.NAZENGINEERING.COM

ENGINEERS STAMP:

NO. 19677  
Exp. 9/30/23  
ELECTRICAL  
STATE OF CALIFORNIA

DATE SIGNED: 06/02/23

PROJECT NUMBER: 2314-03

DRAWN BY: RF

CHECKED BY: JB

REVISIONS

REV	DATE	DESCRIPTION	BY
0	05/12/23	IFP PLAN PACKAGE	JB
1	06/02/23	PLAN CHECK #1	JB

SITE ADDRESS

MARINA DEL REY LOT 5

DEPARTMENT OF  
REGIONAL PLANNING APPROVED

SHEET TITLE

ELECTRICAL  
DETAILS


SHEET NUMBER

E301

ELECTRICAL DETAIL GENERAL NOTES

NOTES:

1. USE DUCT SEAL COMPOUND TO SEAL ENDS OF CONDUIT (TYPICAL FOR ALL CONDUITS AT EACH END).
2. BUSHINGS SHALL BE USED ON ALL ELECTRICAL CONDUIT STUBS.
3. CONTRACTOR SHALL VERIFY ALL DIMENSIONS WITH THE LATEST MANUFACTURER SPECIFICATIONS FOR DISPENSER PRIOR TO CONSTRUCTION.
4. ANCHOR ALL EQUIPMENT PER MANUFACTURER'S REQUIREMENTS.
5. MINIMUM EQUIPMENT PAD DIMENSIONS INDICATED. CONTRACTOR SHALL ADJUST PER SITE CONDITIONS AND EQUIPMENT SIZE AS REQUIRED.

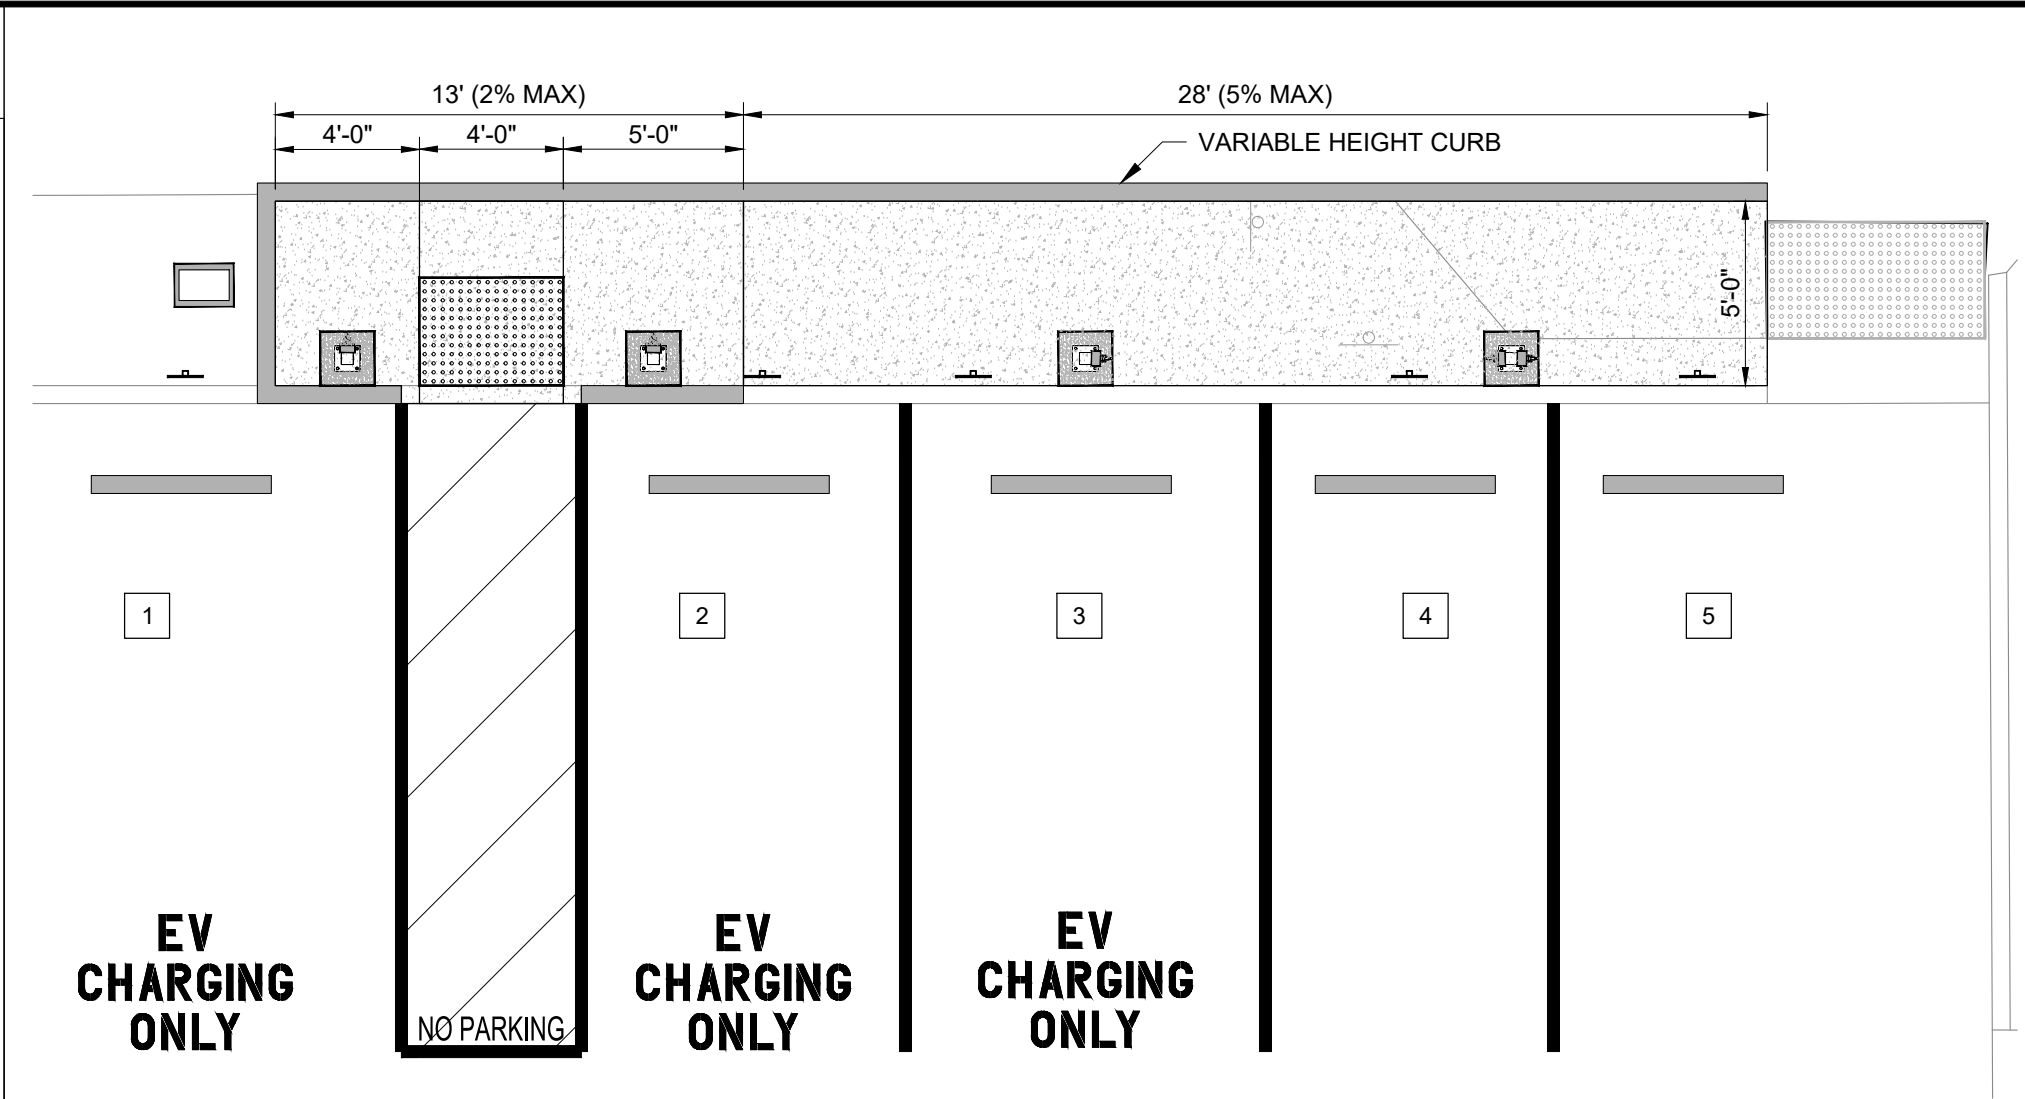


PEDESTRIAN WALKWAY AND DETECTABLE WARNING NOTES:

1. DETECTABLE WARNINGS AND DETECTABLE DIRECTIONAL TEXTURE SHALL ADHERE TO CBC 11B-705.
2. THE DETECTABLE WARNING MAY BE REDUCED TO 24" MINIMUM PER CBC 11B-705.1.2.2.1 EXCEPTION.
3. PEDESTRIAN WALKWAY SHALL ADHERE TO CBC 11B-705.1.2.2.

4 ACCESSIBLE PEDESTRIAN WALKWAY DETAIL


SCALE: 3/4" = 1'-0"

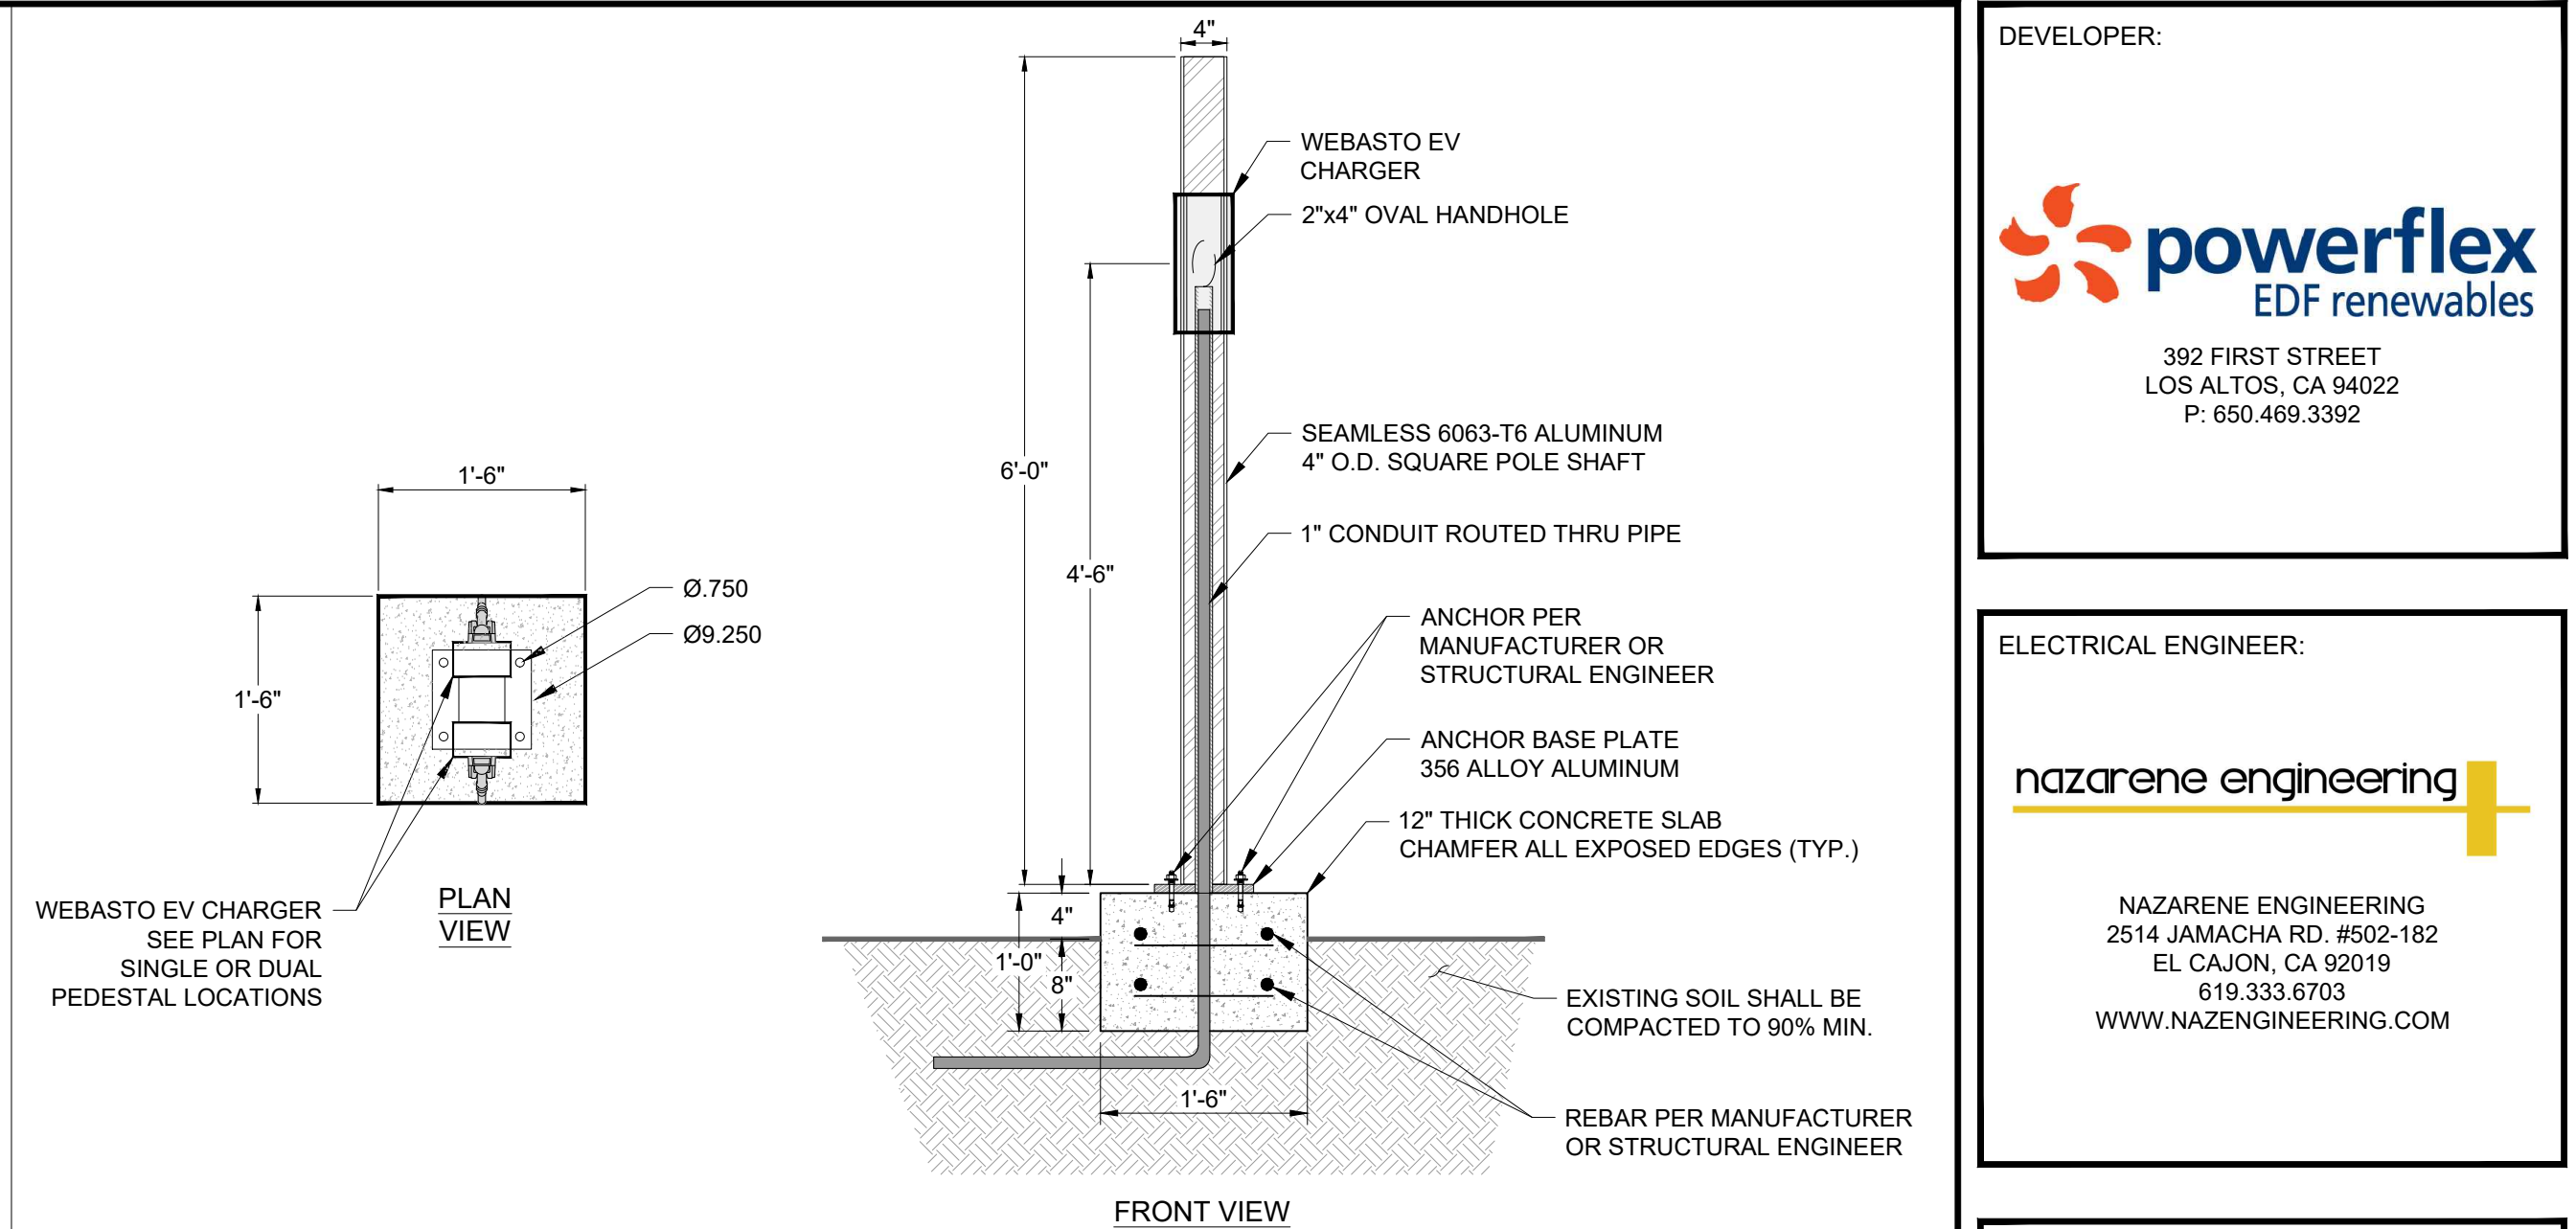


1 TYPICAL EV EQUIPMENT PAD SINGLE OR DUAL PEDESTAL DETAIL 7.7KW WEBASTO CHARGER

SCALE: 3/4" = 1'-0"

ENGINEERS STAMP:

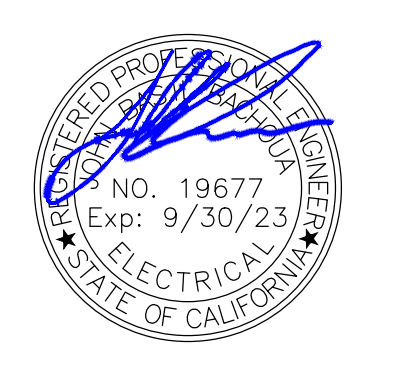

DATE SIGNED: 06/02/23

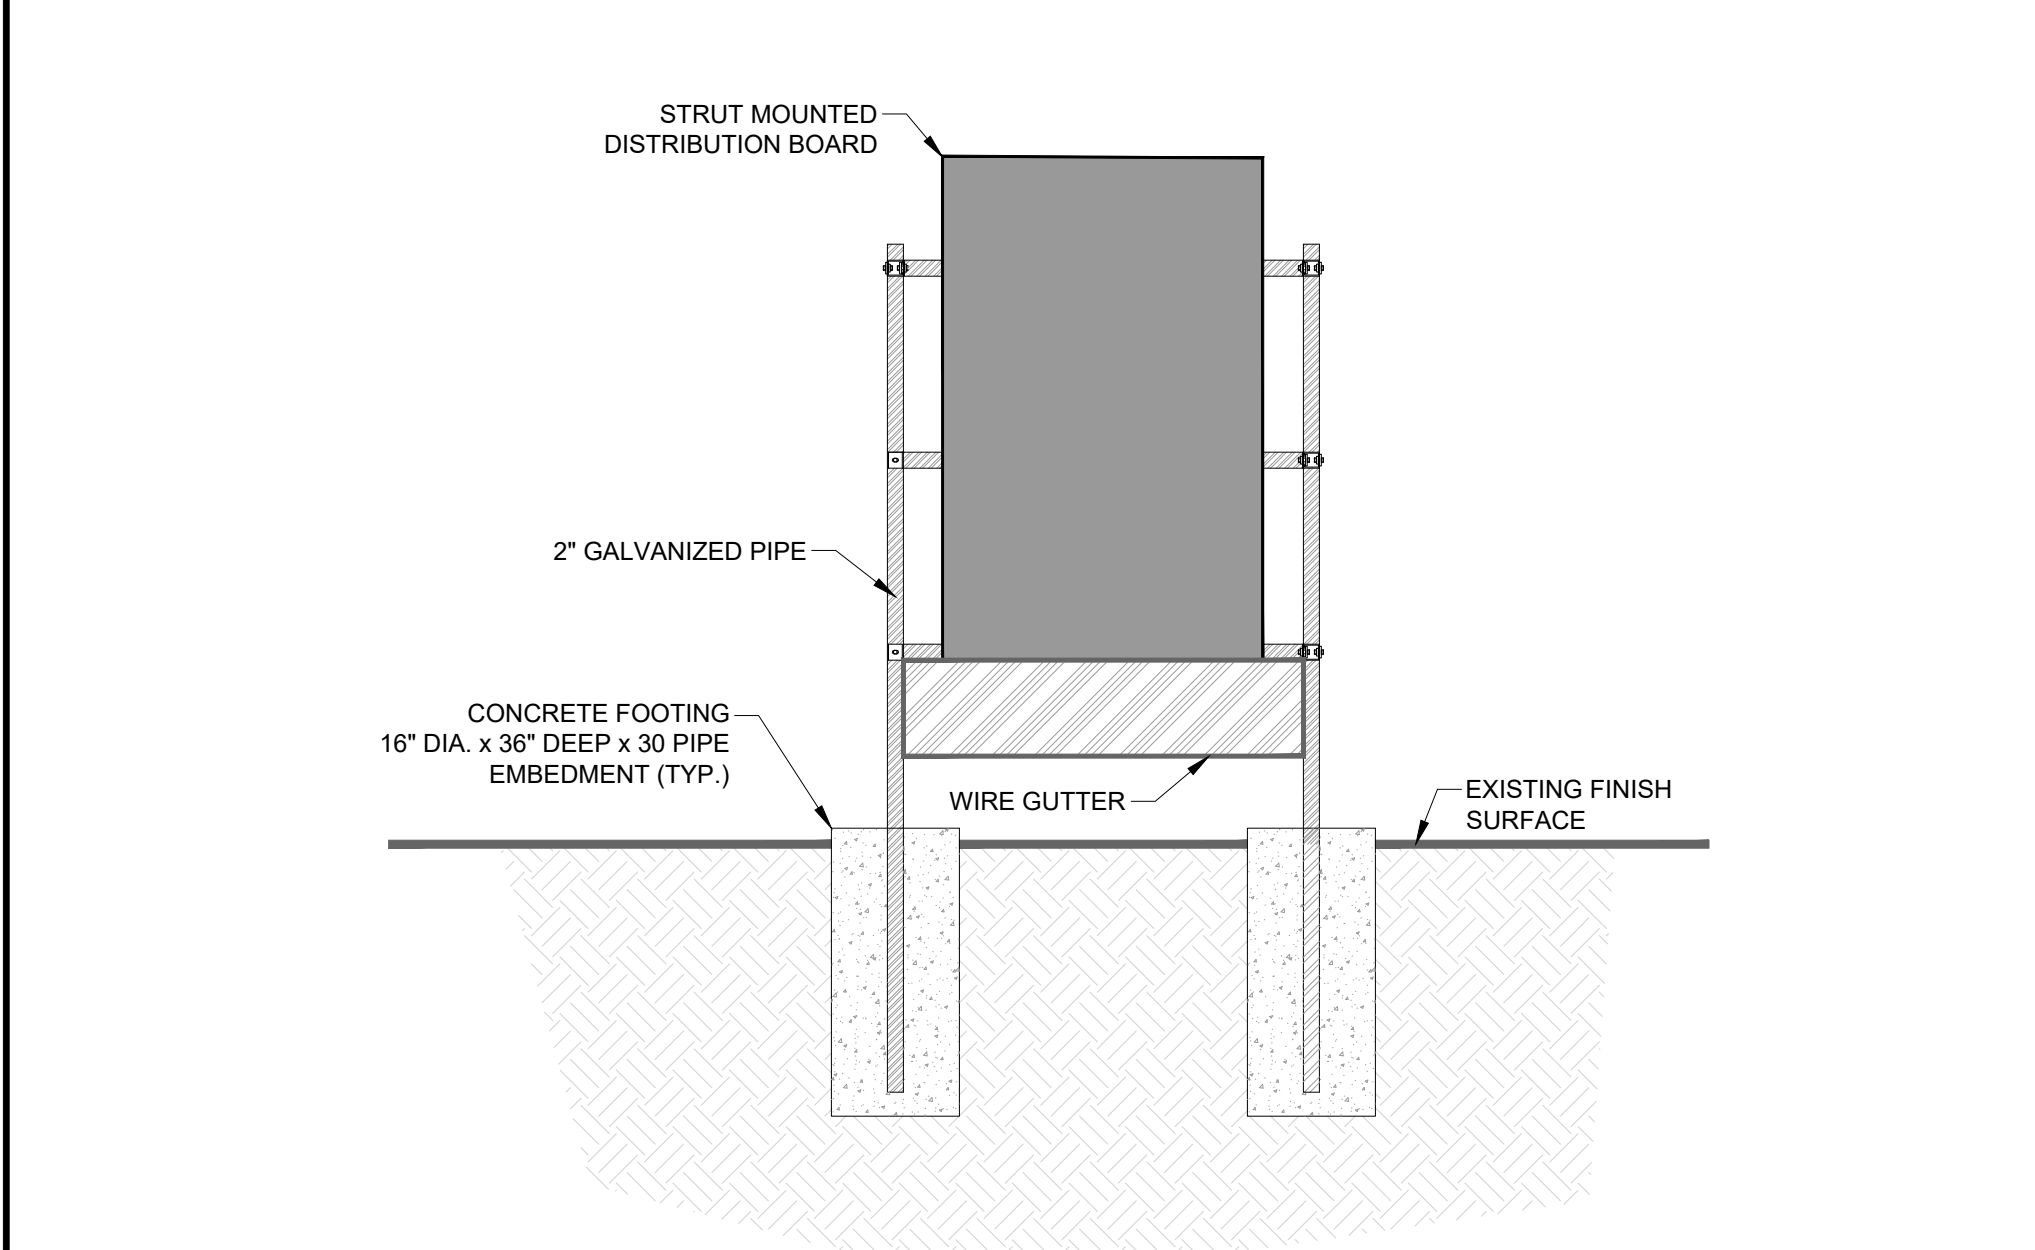


7 TYPICAL STRUT MOUNTED EQUIPMENT DETAIL DISTRIBUTION BOARD

SCALE: 1/2" = 1'-0"

BOLLARD NOTES:


1. DIMENSION BETWEEN BOLLARD TO BOLLARD FACE SHALL BE 64" MAXIMUM.
2. CONTRACTOR SHALL INSTALL TRANSFORMER BOLLARDS AS REQUIRED BY UTILITY STANDARDS.
3. ALIGN BOLLARD PIPE & GROUND INSERT SO EYES ARE LOCATED AT BACK AND FRONT OF BOLLARD (NOT WITHIN TRAVEL WAY).

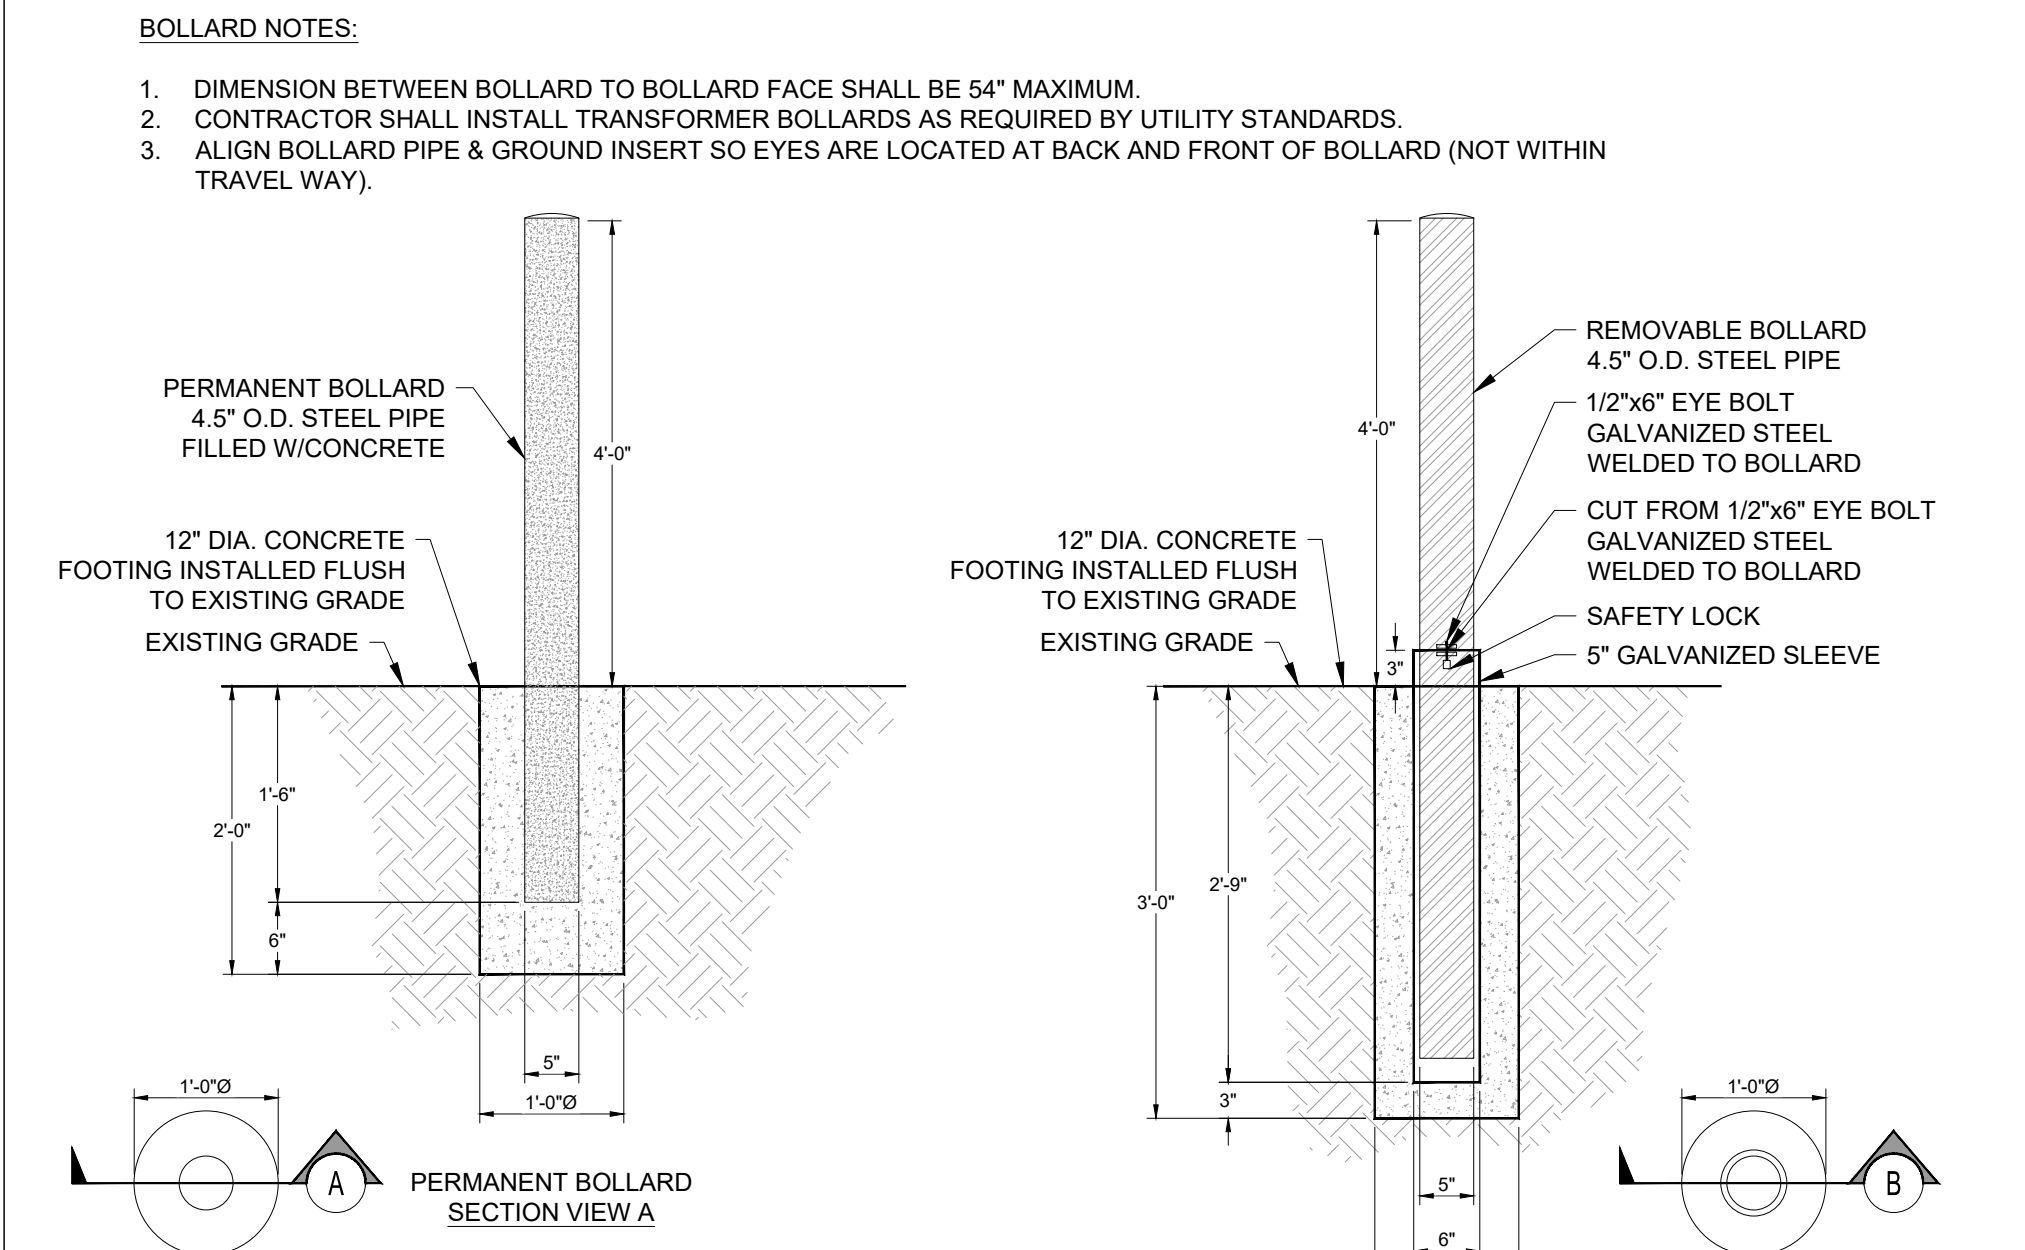


5 PERMANENT AND REMOVABLE BOLLARD DETAILS

SCALE: 3/4" = 1'-0"

2 NOT USED

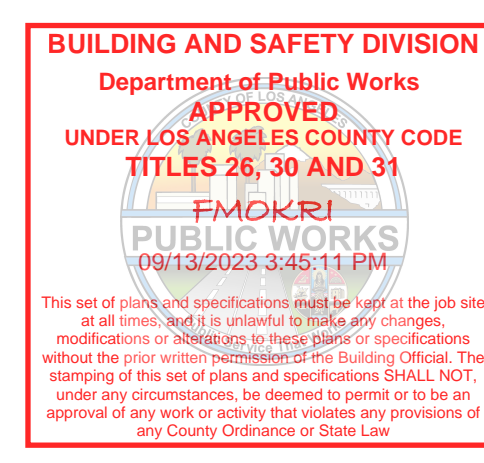


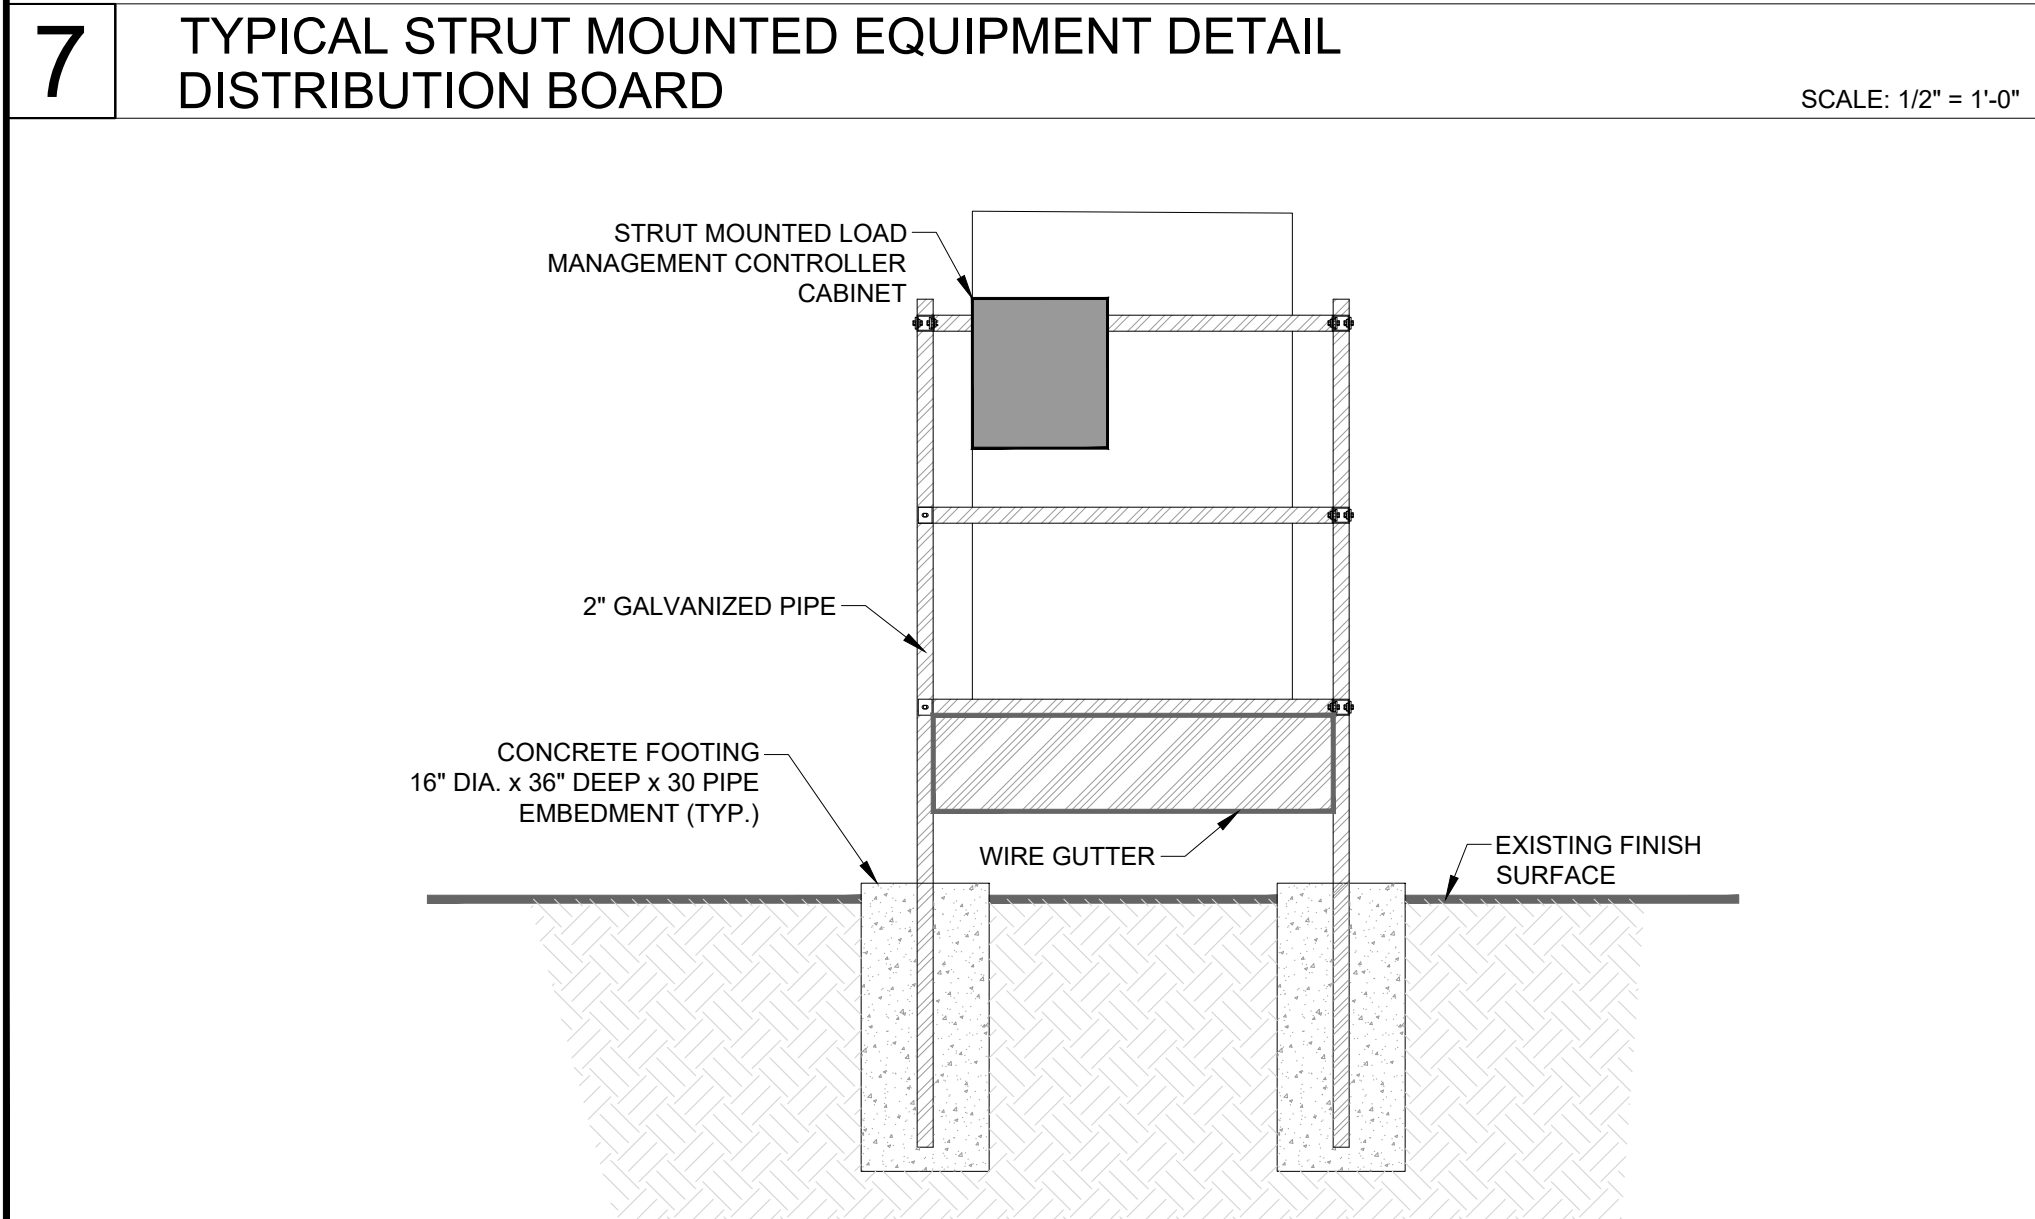

8 STRUT MOUNTED EQUIPMENT DETAIL NEXTUS COMMUNICATIONS CONTROLLER

SCALE: 1/2" = 1'-0"

6 NOT USED

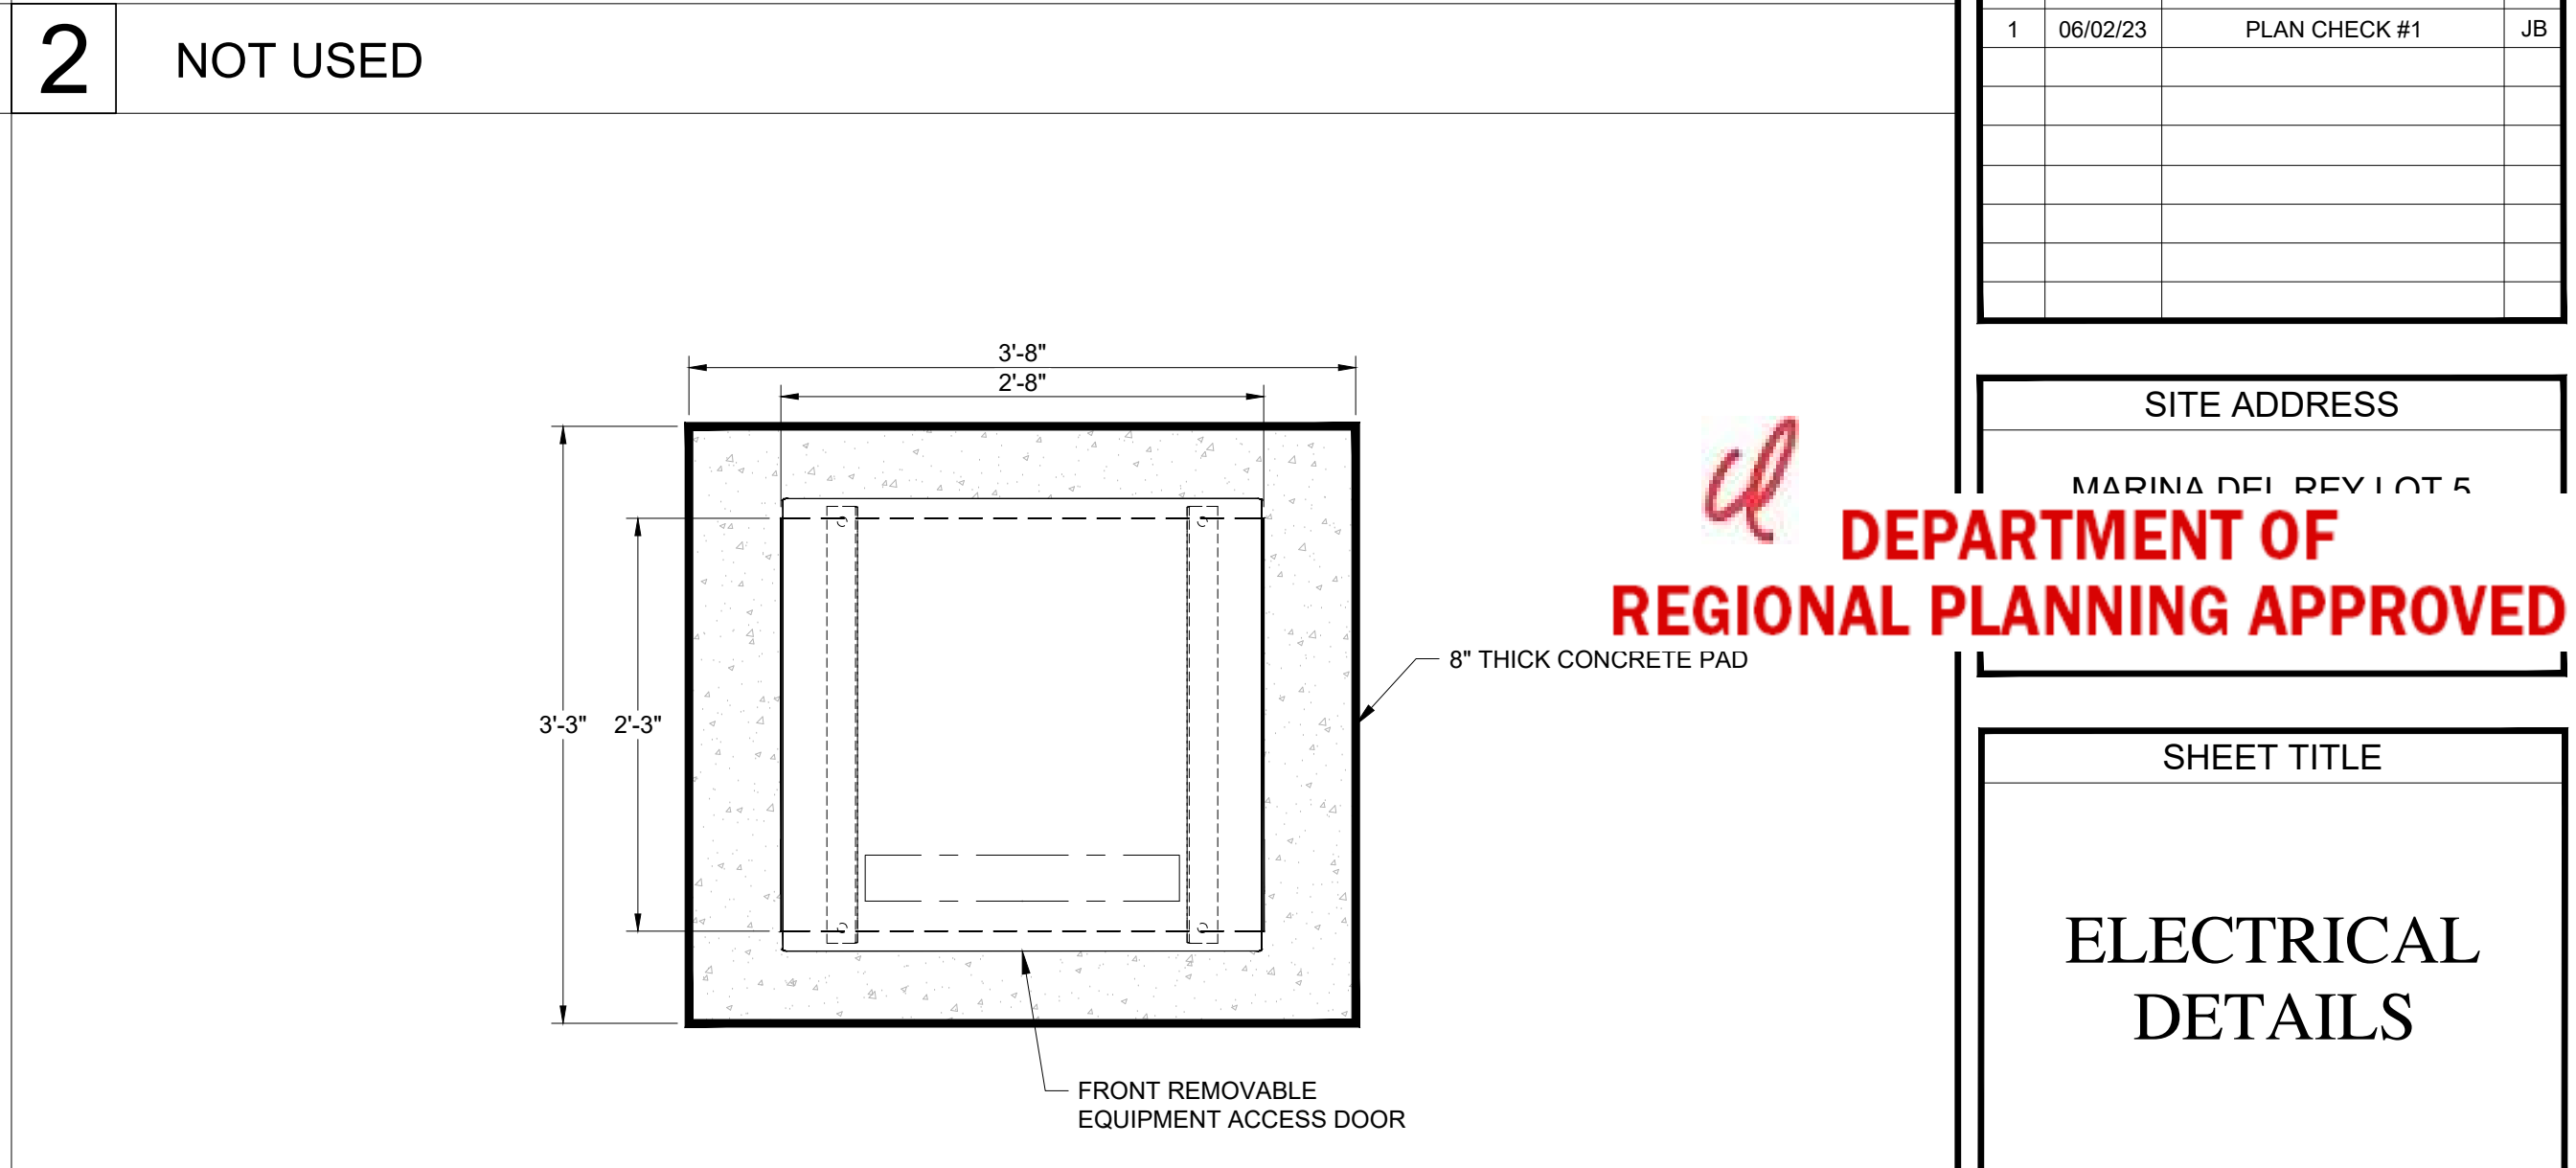

3 EV EQUIPMENT PAD DETAIL 150KVA TRANSFORMER

SCALE: 1" = 1'-0"

SITE ADDRESS

MARINA DEL REY LOT 5

DEPARTMENT OF REGIONAL PLANNING APPROVED


SHEET TITLE

ELECTRICAL DETAILS

SHEET NUMBER


E302

DEVELOPER:




392 FIRST STREET  
LOS ALTOS, CA 94022  
P. 650.469.3392

ELECTRICAL ENGINEER:



NAZARENE ENGINEERING  
2514 JAMACHA RD. #502-182  
EL CAJON, CA 92019  
619.333.6703  
WWW.NAZENGINEERING.COM

ENGINEERS STAMP:

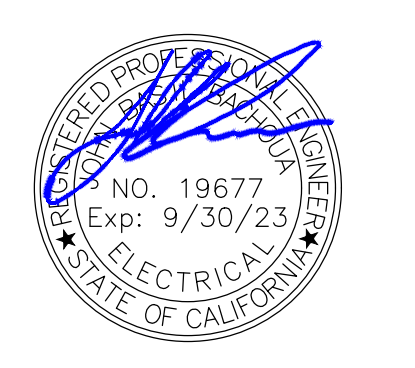

DATE SIGNED: 06/02/23

PROJECT NUMBER: 2314-03

DRAWN BY: RF

CHECKED BY: JB

REVISIONS

REV	DATE	DESCRIPTION	BY
0	05/12/23	IFP PLAN PACKAGE	JB
1	06/02/23	PLAN CHECK #1	JB

NOT USED

SITE ADDRESS

MARINA DEL REY LOT 5

DEPARTMENT OF REGIONAL PLANNING APPROVED

SHEET TITLE


ELECTRICAL DETAILS

SHEET NUMBER

E302

## Nexus Core

**Nexus Core** is the central brain where the energy optimization and Adaptive Load Management functions are executed and dispatched to the Distributed Energy Resources at your site. **Core** contains a powerful central computer for optimization and historian capabilities and network communication including ethernet switch. **Core** supports Zigbee 3.0 and Wi-Fi/OCPP communications to EV chargers and other IOT devices.

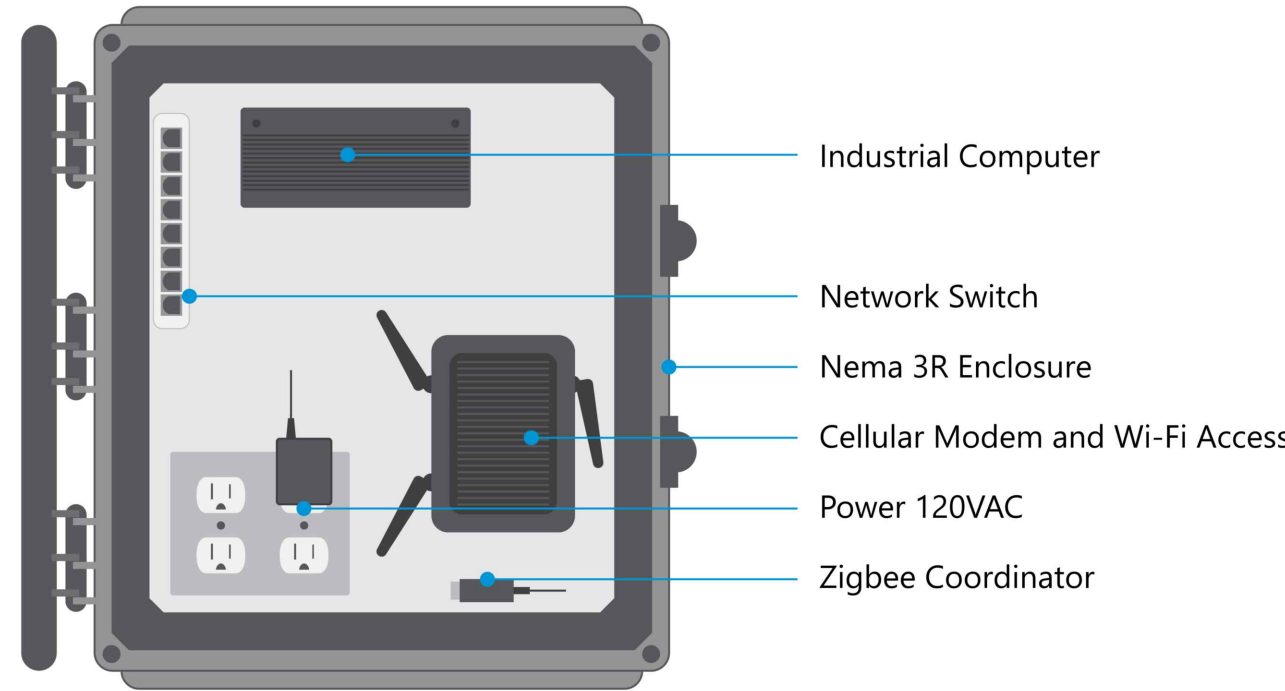

### Features

- Industrial PC:** Provides optimization, load management, communication coordination, and data historian services
- Network Switch:** Ethernet switch for communications to Nexus nodes, Distributed Energy Resources, and with Cortex, PowerFlex's cloud-based energy management system
- Modem:** Robust cellular 4G/LTE modem with integral Wi-Fi access point

### Options

- Serial RS232/RS485 communications interface
- Optical single or multimode fiber communications interface
- Integrated heater for locations with low ambient temperatures
- External transformer for 208VAC, 240VAC, 277/480VAC or higher voltage installations
- External UPS for critical applications

[site-support@powerflex.com](mailto:site-support@powerflex.com)

[powerflex.com](http://powerflex.com)

## Nexus Core

### Technical Specifications

#### Enclosure

Material	Polycarbonate
Color	Gray
Dimensions	H: 18.7in (48cm) W: 16.9in (43cm) D: 12.5in (32cm)
Rating	NEMA 3R/IP24 Min T: 32F (0C) Max T: 122F (40C) Dual 18W thermostat-controlled fan Integrated heater
Weight	Max 31.5lb (14kg)
Power	120VAC, up to 500W

#### Modem

Type	Dual 4G LTE Modem
Ethernet	1 GbE, 1 FE (LAN/WAN switchable)
Providers	AT&T, Verizon, T-Mobile
Throughput	75 Mbps (Firewall)
Wi-Fi	802.11 b/g/n (Wi-Fi 4)

#### Network Switch

Ports	16-port PoE+ (8) GbE, 802.3at PoE+ ports (8) GbE RJ45 ports
PoE supply	52W total

#### Communications

Protocols	Ethernet Modbus TCP/RTU DNP3 OCPP Zigbee 3.0
-----------	--

[site-support@powerflex.com](mailto:site-support@powerflex.com)

[powerflex.com](http://powerflex.com)



## TurboDX

Next Generation Electric Vehicle Charger



### Highest Level of Safety Available

Your safety is our #1 priority. That's why we built TurboDX with the most advanced and state-of-the-art safety features available. TurboDX ensures a safe and reliable charge every time with leakage and thermal detection, auto-restart and recovery and ground detection against faults. It is UL and cUL listed, safe for indoor or outdoor use and can withstand extreme weather conditions. TurboDX meets the rigorous safety standards mandated by our automotive partners and is backed by a 3-year warranty.

### Flexible, Simple and Built for Your Life

Charging your EV should be a seamless experience. TurboDX is a simple plug and play solution. No need to download extra apps, manage notifications, or push extra buttons. With TurboDX all you need to do is plug it in – it's that easy. TurboDX has a slim and compact design which allows it to fit in most garage configurations. For public uses, TurboDX can accommodate a dual, triple or quad installation. The modular design allows for more cars to charge simultaneously and to expand as more chargers are needed. Your life is busy enough, your charging experience shouldn't be.

#### Key Features:

- State-of-the-art safety features
- Slim compact design
- Durable aluminum rear enclosure
- Quick read status indicators
- Fully potted electronics reduces the risk of thermal shock, thermal dissipation, and static shock
- Revolutionary leakage and thermal detection
- "Auto-Reboot" for issues during self-check process
- "Auto Recovery" if changes in temperature or voltage is detected
- Missing ground detection
- UL and cUL certified
- Easy to use, simply plug-in and charge

### Technical Specifications

	TurboDX 16A	TurboDX 32A
Voltage	208 – 240 VAC (Split Phase or Phase Ground)	
Current	16A	32A
Circuit Breaker Rating	20A	40A
Frequency	50-60Hz	
Maximum Power Output @240V	3.8kW	7.7kW
Cable Length	up to 25 ft (7.62m) available	
Weight	7.75lbs (3.5kg)	12lbs (5.5kg)
Dimensions	12" x 5" x 3.5" (approximate)	
Storage Temperature	-40C (-40°F) to +60C (140°F)	
Operating Temperature	-40C (-40°F) to +55C (131°F)	
Indoor / Outdoor	Yes   Type 4 (IP66) enclosure	
Relative Humidity	Up to 95% non-condensing	
Charge Coupler	SAE J1772 compliant	



**DEPARTMENT OF  
REGIONAL PLANNING APPROVED**

DEVELOPER:




392 FIRST STREET  
LOS ALTOS, CA 94022  
P: 650.469.3392

ELECTRICAL ENGINEER:

**nazarene engineering**

NAZARENE ENGINEERING  
2514 JAMACHA RD. #502-182  
EL CAJON, CA 92019  
619.333.6703  
WWW.NAZENGINEERING.COM

ENGINEERS STAMP:

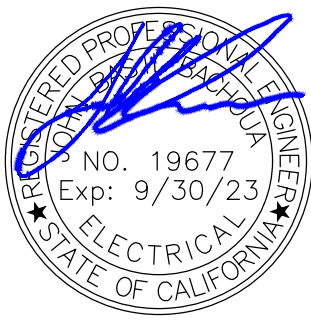

DATE SIGNED: 06/02/23

PROJECT NUMBER: 2314-03

DRAWN BY: RF

CHECKED BY: JB

### REVISIONS

REV	DATE	DESCRIPTION	BY
0	05/12/23	IFP PLAN PACKAGE	JB
1	06/02/23	PLAN CHECK #1	JB

### SITE ADDRESS

MARINA DEL REY LOT 5

### SHEET TITLE

**EQUIPMENT  
DATASHEETS**


### SHEET NUMBER

**E401**

## EV CHARGING VINYL WRAP OPTIONS



**Option 1**

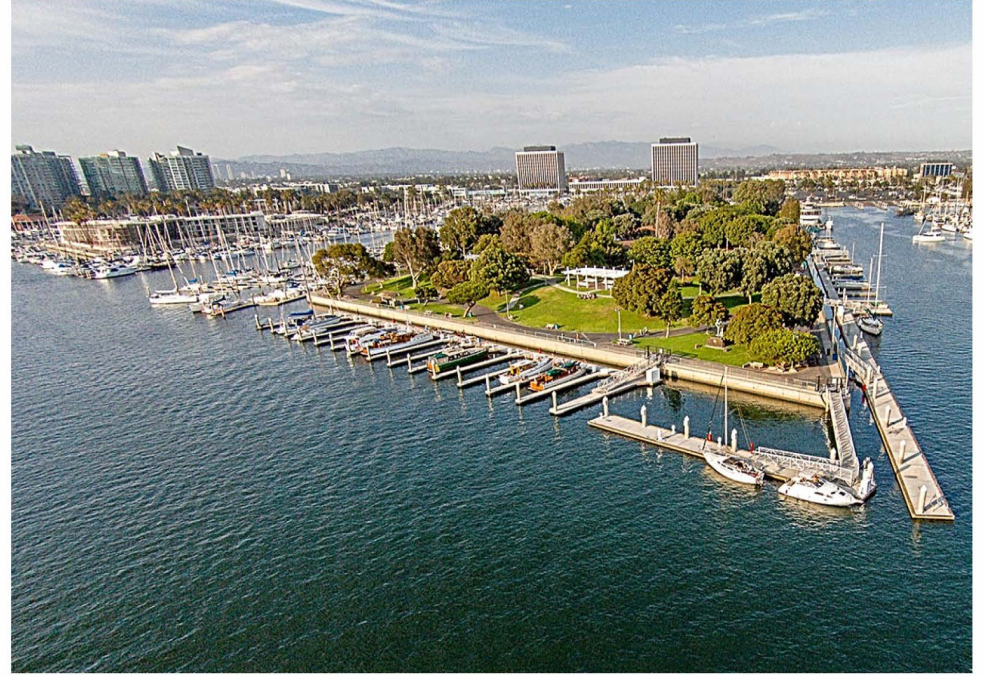

**Option 2**



**Option 3**

## Examples of EV Charging Posts Installed at Other DBH Sites





Caring for Our Coast



**Gary Jones**  
Director

**Amy M. Caves**  
Chief Deputy Director

**Carol Baker**  
Deputy Director

**LaTayvius R. Alberty**  
Deputy Director

February 21, 2024

TO: Design Control Board

FROM: Gary Jones, Director

SUBJECT: **ITEM 6A - ONGOING ACTIVITIES REPORT**

**BOARD ACTIONS ON ITEMS RELATING TO MARINA DEL REY**

On November 7, 2023, the Board of Supervisors (BOS) approved the proposed Aubrey Austin Park Rehabilitation Project, Capital Project No. 89222, located at 4500 Via Marina in Marina del Rey, with a total project budget of \$1,500,000. In addition, the BOS approved an appropriation adjustment to transfer \$973,000 from the Services and Supplies Marina Replacement Accumulative Capital Outlay Fund to the project to fully fund the project, authorized the Director of Public Works to deliver the proposed project using a Board-approved Job Order Contract, and authorized the Director of Beaches and Harbors to waive the right-of-entry permit fees for the project.

On December 19, 2023, the BOS approved the revised total project budget of \$535,000, an increase of \$187,000 from the previously Board-approved budget of \$348,000, for the Marina Del Rey Boat Launch Restroom Renovation Project, Capital Project No. 89158, to fully fund the scope of work. In addition, the BOS approved an appropriation adjustment to transfer \$187,000 from the Marina Replacement Accumulative Capital Outlay Fund Services and Supplies budget to the project.

On January 9, 2024, the BOS, acting as the Governing Body of the County Flood Control District, approved the Boone Olive Pump Station Upgrade Project in the City of Los Angeles and adopted the plans and specifications at an estimated construction contract amount between \$4,500,000 and \$6,750,000. In addition, the BOS advertised for bids to be received before 11:00 a.m. on February 27, 2024, and found pursuant to State Public Contract Code, Section 3400, that it is necessary to specify designated items by specific brand name in order to match other products in use on a particular public improvement either completed or in the course of completion. Furthermore, the BOS instructed the Director of Beaches and Harbors to waive parking fees in an estimated amount of \$30,000 for 24 vehicles at Parking Lots 7 or 8 in the unincorporated community of Marina del Rey, to allow for staging of construction equipment for the duration of construction.



**REGIONAL PLANNING COMMISSION'S CALENDAR**

No items related to Marina del Rey were on the October, November, or December 2023 Regional Planning Commission's agenda.

**CALIFORNIA COASTAL COMMISSION CALENDAR**

No items related to Marina del Rey were on the October, November, or December 2023 California Coastal Commission agenda.

**FUTURE MAJOR DESIGN CONTROL BOARD ITEMS**

There are no future major Design Control Board items at this time.

**SMALL CRAFT HARBOR COMMISSION MINUTES**

The August and September 2023 Small Craft Harbor Commission meeting minutes are attached. The October 2023, December 2023, and January 2024 meetings were cancelled. The November 2023 meeting minutes are pending.

**REDEVELOPMENT PROJECT STATUS REPORT**

The updated "Marina del Rey Redevelopment Projects Report" is attached.

GJ:WO:lr  
Attachments (3)

## **SMALL CRAFT HARBOR COMMISSION MINUTES**

### **August 29, 2023**

**Commissioners:** Nathaniel Salazar, Chair; Gregory Gorman, Vice Chair; Bernard Kozacik; Richard Montgomery; Allyn Rifkin; (excused absence)

**Department of Beaches and Harbors (DBH):** Amy Caves, Chief Deputy Director; LaTayvius Alberty, Deputy Director; Ivy Bordenave-Priestly, Lease Specialist; Amir Tadros, Senior Real Property Agent

**County:** Parjack Ghaderi, Principal Deputy County Counsel

#### **Item 1 - Call to Order and Pledge of Allegiance**

Chair Salazar called the meeting to order at 10:00 a.m., followed by the Land Acknowledgement Statement and the Pledge of Allegiance. Ivy Bordenave-Priestly read the hybrid meeting procedures.

#### **Item 2 – Approval of Minutes**

**Motion to approve April 20, 2023, and May 10, 2023 Meeting minutes by Vice Chair Gorman, seconded by Mr. Montgomery.**

**Ayes: 4, Chair Salazar, Vice Chair Gorman, Mr. Kozacik and Mr. Montgomery**

#### **Item 3 – Communication from the Public**

There was no communication from the public.

#### **Item 4 – Communication with the Commissioners**

The commissioners disclosed communication from the Marina del Rey Lessees' Association, and, Pacific Ocean Management.

#### **Item 5a – Marina Sheriff**

Sergeant Ron Knolls presented the Sheriff's report.

Mr. Montgomery asked for an explanation of the liveaboard permit expiration process and the citation process.

Sergeant Knolls explained that once identified as a liveaboard, they go through the process with the dock master and through yearly inspections. He further explained that once the inspection is passed some drop-off, move, or sell their boat, but, remain registered in the sheriff's system until their status was identified and removed. Individuals identified as "sneakaboards" are issued notices, and dock master contacts them via email, phone, and deputies contact them to get registered. Citations are issued as a last resort.

#### **Item 5b – MdR and Beach Special Events**

Catrina Love reported on the summer concerts, sound relaxation with meditation, sunset yoga, and water bus service which ends Labor Day weekend.

#### **Item 5c – Marina Boating Section Report**

Michael Blenk reported that Anchorage 47 has one 42-feet, five 38-feet, three 34-feet, one 30-feet, one 28-feet, seven 24-feet, six 27-feet, and five 22-feet vacant slips available. Parcel 77 powerboat storage is full, and Mast-Up storage has 36 spaces available. He announced that dinghy storage for kayaks or paddleboards is now available at parcel 77.

**Item 5d – Marina del Rey Maintenance Report**

Jose Bedolla reported on the breakwater light project and Dock No. 2 at the public boat launch ramp.

Mr. Montgomery inquired about the condition of the trash interceptor at Ballona Creek.

Jose Bedolla replied that DPW could provide the information; however, during the storm, it worked well and the trash level was minimal.

**Item 6a**

None

**Item 7a – New Business – Marina del Rey Affordable Housing Policy Update**

Porsche Nauls presented the report.

Pam Gore agreed with more affordable housing but expressed concern about the potential traffic problem on Parcel 147.

David Levine, Marina del Rey Lessees Association, spoke of their concerns about the latest draft and requested to move the endorsement to a later date to meet with the County staff to discuss issues.

Eric Grossman, Equity Residential, agreed with more affordable housing but requested a postponement on the item until further review.

Patricia Younis spoke of Marina del Rey's real estate and economic structures and noted that Marina del Rey is very different than any of the other Los Angeles County areas. Marina del Rey is a compilation of ground leases many of which were highly and very expensively negotiated over many years. The county has a moral, legal, and ethical responsibility to live up to its lease terms it negotiated with its lessees. Lastly, she urged the County to honor the lease agreements in place.

Debra Fixen, Marina del Rey Lessee Association, agreed with the 30 percent goal and urged the County to look at existing leases, consider the way they were written, and consider the financial ramifications of changing those agreements. She also requested a continuation of this item until further analysis can be given.

Kevin McKee, Marina Harbor Apartments, supported additional affordable housing and expressed concern about the updated policy received only the night before. He asked for additional time to work with all stakeholders involved to develop a plan that considers all stakeholders.

Tim Riley, Marina del Rey Lessees Association, supported the 30 percent affordable housing goal but needs more time to work with the County through additional dialogue.

Vice Chair Gorman expressed disappointment in the comments made by the public speakers and noted that this item was an emergency. He clarified that the County cannot change the existing lease that has been agreed to.

Mr. Montgomery requested clarification on the goal of 30 percent. Is it up to or is it a minimum of 30 percent?

Porsche replied that the goal is to achieve 30 percent in the Marina-wide.

Amy Caves explained that the goal is 30 percent Marina-wide; however, on a project to which this policy applies, it will be 30 percent. If a lessee is not seeking any discretionary amendment such as a major extension, then this policy will not apply to that lease. If a new project or substantial rehab project occurs that reopens the lease for renegotiations it will require 30 percent affordable units for that project.

Mr. Montgomery inquired if replacement housing obligations include the extremely low income.

Porsche replied affirmatively and explained that a replacement lower-income unit must be replaced with a likekind unit.

Mr. Montgomery also expressed concern regarding the one-day, short review time.

Amy Caves explained that DBH staff met with housing advocacy groups and the Marina del Rey Lessees Association. In those meetings, they discussed major revisions to the policy in clarification of the issues brought up by the lessees. She further explained that although they had a limited time to review the updated policy, there were a handful of clarification revisions and nothing of substance.

Maral Tashjian explained that the changes were minor and redline copies were provided to the lessees so they could see where the changes occurred.

Mr. Kozacik supports the 30 percent goal and expressed concern about the limited time for the review of the policy.

Chair Salazar also mentioned the shortness of one day for a review of the policy.

Amy Caves clarified that the policy was made available a couple of weeks ago.

Vice Chair Gorman stated that he did receive the policy weeks ago and did not note any major changes.

Chair Salazar noted the importance of moving forward with this policy due to the homelessness issue in Los Angeles. He noted that DBH assured that all the groups involved will participate in the policy implementation guidelines.

**Motion to approve the Marina del Rey Affordable Housing Policy Update by Mr. Montgomery, seconded by Vice Chair Gorman**

**Ayes: 3, Chair Salazar, Vice Chair Gorman, and Mr. Montgomery**  
**Abstain:1, Mr. Kozacik**

**Item 8 – Staff Reports**

Ivy Bordenave-Priestley presented the staff report.

**Adjournment**

Chair Salazar adjourned the meeting at 11:15 am.

**SMALL CRAFT HARBOR COMMISSION MINUTES**  
**September 13, 2023**

**Commissioners:** Nathaniel Salazar, Chair; Gregory Gorman, Vice Chair; Richard Montgomery; Allyn Rifkin; (excused absence), Bernard Kozacik; (excused absence)

**Department of Beaches and Harbors (DBH):** LaTayvius Alberty, Deputy Director; Steve Penn, Chief of Asset Management Division; Ivy Bordenave-Priestly, Lease Specialist; Amir Tadros, Senior Real Property Agent

**County:** Sevanna Hartonians, Deputy County Counsel

**Item 1 - Call to Order and Pledge of Allegiance**

Chair Salazar called the meeting to order at 10:00 a.m., followed by the Land Acknowledgement Statement and the Pledge of Allegiance. Ivy Bordenave-Priestly read the hybrid meeting procedures.

**Item 2 – Approval of Minutes**

**Motion to approve July 25, 2023 Meeting minutes by, Mr. Montgomery seconded by Vice Chair Gorman.**

**Ayes: 3, Chair Salazar, Vice Chair Gorman and Mr. Montgomery**

**Item 3 – Communication from the Public**

Mack Steagall expressed concern regarding the poor condition of the main channel markers.

Elliot Zimmerman asked for dredging project updates.

**Item 4 – Communication with the Commissioners**

None

**Item 5a – Marina Sheriff**

Sergeant Ron Knolls presented the Sheriff's report.

Pam Gore expressed her gratitude for the Sheriff's efforts with the illegal charters issue.

**Item 5b – MdR and Beach Special Events**

Catrina Love reported on Beach Eats, Dance MdR, Free Marina Movie Nights, Beach Shuttle, and Marina Drum Circle.

**Item 5c – Marina Boating Section Report**

Michael Blenk reported that Anchorage 47 has one 42-feet, five 38-feet, four 34-feet, one 30-feet, three 28-feet, seven 24-feet, six 27-feet, and four 22-feet vacant slips available. Parcel 77 powerboat storage is full, and Mast-Up storage has 36 spaces available.

**Item 5d – Marina del Rey Maintenance Report**

Jose Bedolla reported on the breakwater light project and mentioned that the dredging project is being worked on.

Vice Chair Gorman requested a timeline for the dredging project.

**Item 6a**

None

**Item 7a – New Business – Proposed License Agreement To Southland Farmers’ Market Association For Marina del Rey Farmers’ Market**

Catrina Love presented the report.

**Motion to approve the Marina del Rey Proposed License Agreement To Southland Farmers’ Market Association For Marina del Rey Farmers’ Market by Mr. Montgomery, seconded by Vice Chair Gorman**

**Ayes: 3, Chair Salazar, Vice Chair Gorman, and Mr. Montgomery**

**Item 8 – Staff Reports**

Steve Penn presented the staff report.

Elliot Zimmerman spoke about the illegal charter enforcement efforts of Los Angeles County, Department of Beaches and Harbors.

Vice Chair Gorman inquired about the California Yacht Club’s promenade project status and the enforcement of the illegal charters.

Steve Penn stated that a meeting with the California Yacht Club has been scheduled to discuss their design.

Mr. Montgomery asked who is in charge of the insurance for private docks.

Steve Penn explained that there are insurance requirements in the ground leases between the County and lessees, which DBH administers; and also insurance requirements in the slip rental agreement between the lessees and their slip tenants, which DBH does not administer.

**Adjournment**

Chair Salazar adjourned the meeting at 10:46 a.m.

**Marina del Rey Redevelopment Projects Report  
As of February 21, 2024**

Parcel No. Project Name	Representative	Redevelopment Proposed	Massing and Parking	Status
113 -- Mariner's Village	Mark Wagner	* Renovation of 981 apartments  * Improvements to promenade	<b>Massing</b> – Existing buildings to remain.  <b>Parking</b> – Existing parking to remain.	<p><b>Proprietary</b> – Item opened on 9/23/2013. On October 30, 2018, the Los Angeles County Board of Supervisors approved an option for an amended at restated lease. The revised project will include 20% affordable units. The Option for the Amended and Restated Lease was extended for one year, until October 29, 2023, at the October 18, 2022 Board of Supervisors Meeting. In October 2023, Lessee exercised the Option for the Amended and Restated Lease. In October 2023, Lessee and County fully executed the Amended and Restated Lease. In December 2023, Lessee recorded the CC&amp;Rs and Memorandum of Lease with LA County Recorder's Office.</p> <p><b>Regulatory</b> – The Regional Planning Commission approved an after-the-fact Coastal Development Permit (CDP) for the previous removal of waterbird nests. The appeal of that CDP was approved by the Coastal Commission in September 8, 2021. Lessee is tentatively scheduled to present at the Marina del Rey Design Control Board meeting scheduled for January 19, 2022. Lessee's presentation at Jan 19, 2022's DCB meeting was continued to allow more time to review the proposal. Staff scheduled ex-parte meetings with Meg Coffee and Chair Cho. Lessee's design plans were approved at the March 2022 DCB meeting.</p>



Caring for Our Coast


♦ ♦ ♦  
**Gary Jones**  
Director

**Amy M. Caves**  
Chief Deputy Director

**Carol Baker**  
Deputy Director

**LaTayvius R. Alberty**  
Deputy Director

February 21, 2024

TO: Design Control Board  
FROM: Gary Jones, Director   
SUBJECT: **ITEM 6B – MARINA DEL REY SPECIAL EVENTS**

## **MARINA DEL REY EVENTS**

### **BURTON CHACE PARK WALKING CLUB**

Burton Chace Park ♦ Lobby ♦ 13650 Mindanao Way ♦ Marina del Rey  
Tuesdays and Thursdays  
10:30 a.m. – 11:30 a.m.  
Cost: FREE

Looking for a new way to exercise? The Department of Beaches & Harbors (Department) offers a weekly walking group to help you get moving to increase your heart rate and daily step count while taking in beautiful views of the Marina del Rey harbor. Registration is required by emailing [chacepark@bh.lacounty.gov](mailto:chacepark@bh.lacounty.gov).

For more information: Call (424) 526-7910 or email [chacepark@bh.lacounty.gov](mailto:chacepark@bh.lacounty.gov)

### **BURTON CHACE PARK ZUMBA CLASS**

Burton Chace Park ♦ 13650 Mindanao Way ♦ Marina del Rey  
Thursdays  
3:30 p.m. – 4:30 p.m.  
Cost: FREE

Ditch your boring workout and join the Department's free outdoor Zumba class at Burton Chace Park to get cardio-fit while moving to the rhythms of Latin-inspired dance and music! Each class is limited to 15 people. Pre-registration is required for each class by emailing [chacepark@bh.lacounty.gov](mailto:chacepark@bh.lacounty.gov).



For more information: Call (424) 526-7910 or email [chacepark@bh.lacounty.gov](mailto:chacepark@bh.lacounty.gov)

**DRAWING & PAINTING CLASS**

Burton Chace Park ♦ 13650 Mindanao Way ♦ Marina del Rey  
Fridays  
5:00 p.m. – 6:30 p.m.  
Cost: FREE

The Department offers a free drawing and watercolor art class for beginners (ages 14 years and older). Classes are limited to 15 people and supplies are provided. Pre-registration for each class is required by emailing [chacepark@bh.lacounty.gov](mailto:chacepark@bh.lacounty.gov).

For more information: Call (424) 526-7910 or email [chacepark@bh.lacounty.gov](mailto:chacepark@bh.lacounty.gov)

**MARINA DEL REY FARMERS' MARKET**

Lot #11 ♦ 14101 Panay Way ♦ Marina del Rey  
Saturdays  
9:00 a.m. – 2:00 p.m.

Each Saturday, the Department and Southland Farmers' Market Association present the Marina del Rey Farmers' Market, offering fresh, locally grown fruits and veggies (organic and conventional). Also, enjoy delicious prepared and prepackaged foods, and shop for artisanal crafts from local small vendors. Paid parking is available for 50 cents for every 15 minutes.

For more information: Call (424) 526-7900 or visit [marinadelrey.lacounty.gov](http://marinadelrey.lacounty.gov)

**MARINA DEL REY DRAGON BOAT FESTIVAL**

Burton Chace Park ♦ 13650 Mindanao Way ♦ Marina del Rey  
Saturday, March 2, 2024  
7:00 a.m. – 2:00 p.m.

Join the Los Angeles County Dragon Boat Club, in collaboration with the Department, for the Marina del Rey Dragon Boat Festival at Burton Chace Park! This free event will feature 40 local and out-of-state dragon boat teams and clubs competing to be the fastest team on the water. Enjoy arts and crafts, entertainment, and food truck fare. Paddlers between 12 – 80 years old will compete. Spectators are encouraged to cheer and watch the races from Burton Chace Park.

For more information: Visit [lacountydragonboatfestival.com](http://lacountydragonboatfestival.com)

**LOS ANGELES COUNTY BLOOD DRIVE**

Burton Chace Park Community Room ♦ 13650 Mindanao Way ♦ Marina del Rey  
Thursday, March 14, 2024  
10:00 a.m. – 4:00 p.m.

Take part in this lifesaving blood drive hosted by the Department. Please remember to eat well and increase your fluid intake a couple of days before and on the day of your donation appointment. A photo ID is required.

To schedule your donation, visit [redcrossblood.org](https://redcrossblood.org) and enter sponsor code: LACBH or contact Naomi Guzman at [nguzman@bh.lacounty.gov](mailto:nguzman@bh.lacounty.gov).

For more information: Call (800) RED-CROSS

**W.A.T.E.R. PROGRAM SPRING SAILING CLASSES**

Boathouse - Burton Chace Park ♦ 13640 Mindanao Way ♦ Marina del Rey

Los Angeles County Lifeguards will instruct the Department's sailing courses that teach students basic sailing knowledge and terms, boat maintenance and rigging, knot tying, tacking, docking and instruction to ocean sailing. Students will learn to sail on 14-foot Capri sailboats (with main sail and jib) and Laser sailboats. In the final days of the session, students may get experience on Catalina 275 Sport.

Financial aid available. Please call for details.

**2024 SPRING SESSION:**

Dates: March 26 – 29 (4-day session)

Time: 10:00 a.m. – 4:00 p.m.

Ages: 11 – 17 years old

Class Size: 6 – 10 students with 3 Lifeguard instructors

Level: Beginning

Fee: \$300

\*NOTE: Applicants must successfully complete a 100-yard swim test in 2 minutes and 20 seconds to be eligible.

For more information: Call (424) 526-7888 or visit [marinadelrey.lacounty.gov](https://marinadelrey.lacounty.gov)

GJ:CML:da



Caring for Our Coast



**Gary Jones**  
Director


**Amy M. Caves**  
Chief Deputy Director

**Carol Baker**  
Deputy Director

**LaTayvius R. Alberty**  
Deputy Director

February 21, 2024

TO: Design Control Board

FROM: Gary Jones, Director 

**SUBJECT: ITEM 6C – DESIGN CONTROL BOARD ANNUAL REPORT**

Each commission is required to provide an update to the Board of Supervisors about its activities through an annual report. Attached for your consideration is the Design Control Board Annual Report for 2023 which includes the DCB's roles and responsibilities, historical background, annual work plan, accomplishments, and ongoing long-term projects.

GJ:WO:ts

Attachments (1)



Los Angeles County  
Small Craft Harbor Design Control Board  
**2023 Annual Report**



January – December 2023

13837 Fiji Way  
Marina del Rey, CA 90292  
(424) 526-7777  
<http://beaches.lacounty.gov/design-control-board>

**First District (Solis)**

Meg Rushing Coffee

**Second District (Mitchell)**

Genelle Brooks-Petty

**Third District (Horvath)**

Vacant

**Fourth District (Hahn)**

Steven Cho

**Fifth District (Barger)**

Hal Suetsugu

### Mission Statement

The mission of the Small Craft Harbor Design Control Board (DCB) is to ensure that all new improvements and developments in Marina del Rey maintain a high quality of design that complements the water and boating, distinguishes the Marina as a premier waterfront visitor-serving destination, improves the perception of the Marina as a functioning harbor, embraces the right of the public to enjoy this recreational resource, and enhances opportunities for boating and recreation in the Marina.

### Design Control Board Authority

DCB reviews all projects that involve exterior modifications or improvements to properties in Marina del Rey. This includes new development, renovations, repainting, signage, landscaping, and other related activities. DCB reviews a project's site planning, architecture, landscaping, hardscape, and signage to ensure that Marina del Rey is maintained as a desirable location for County residents and visitors alike. Maintaining the Marina supports the County's Strategic Plan Goal III under Strategy III.3.2: Manage and Maximize County Assets. Marina del Rey is owned and overseen by the County, and DCB's oversight protects the County's asset by enforcing architectural and design standards.

The responsibilities of DCB are to: (a) review and approve the architectural design and landscaping of improvements to be constructed in Marina del Rey; (b) advise the Department of Beaches and Harbors (DBH) concerning the implementation of architectural design regulations and policies and related matters; and (c) perform such other duties as may be requested by the Board of Supervisors (BOS).

### Makeup of the Design Control Board

DCB is made up of five members appointed by the BOS to represent each supervisorial district. DCB members must have relevant expertise in architecture, landscape architecture, civil engineering, land development, business management, construction, or planning.

During this report period there were four board members and one vacancy. On May 4, 2023, Board Member Tony Wong, representing the Fifth Supervisorial District, resigned from DCB after 28 years of service. Board Member Hal Suetsugu was appointed to DCB by the BOS on June 6, 2023 to represent the Fifth Supervisorial District.

### Historical Background

On February 23, 1960, BOS adopted an order appointing DCB "to assure conformity on the part of successful bidders who may construct improvements within the Small Craft Harbor." This was followed in 1961 with the BOS approving and adopting the original "Specifications and Minimum Standards of Architectural Treatment and Construction for Marina del Rey." In this document,

DCB was defined as “the Board appointed by the Board of Supervisors to review and approve the architectural design and arrangement of facilities constructed in Marina del Rey.” That document was revised in 1971 and remains in use to this day. DCB has reviewed all projects that were built in the Marina since 1961, when the harbor was first constructed. Today DCB reviews projects based on the parameters established in the 2012 Marina del Rey Local Coastal Program and the 2022 Marina del Rey Design Guidelines.

### Annual Work Plan

DCB’s objective for the coming year is to continue to review architectural design and landscaping improvement projects for Marina del Rey properties. DCB will continue to have scheduled monthly meetings to provide timely project reviews for applicants.

### Annual Accomplishments

DCB held three meetings from January to December 2023. Each meeting held was attended by three DCB members. During this period, DCB reviewed and made recommendations on 15 projects, including signage, electric vehicle charging stations, and building renovations. For example, DCB recommended approval of a final site design for exterior improvements at Marina 41 Apartments, located at the Parcel 102 leasehold. In addition, DCB recommended approval of the Aubrey Austin Park Renovation project. In addition, DCB members participated in various voluntary board briefings to review preliminary designs for projects including the Aubrey Austin Park Renovation, Marina Beach Non-Motorized Boat Storage and Restroom Renovation, and the new Marina del Rey Parking Structure. Additionally, DCB approved numerous new façade improvements and signage requests from new commercial tenants. Below is a list of projects that were reviewed by DCB:

- Parcel 28 Wayfarer Apartments Exterior Paint (Approved)
- Parcel 33 Admiralty Way Wireless Telecommunication in the ROW (Approved)
- Parcel 44 Twelve Nail Bar Tenant Signage (Approved)
- Parcel 44 Winston Pies Tenant Signage (Approved)
- Parcel 44 South Coast Corinthian Yacht Club Awning and Signage (Approved)
- Parcel 44 Tesla Supercharging Stations (Approved)
- Parcel 44 Alfred Tenant Signage (Approved)
- Parcel 49M Marina del Rey Parking Structure Conceptual Design (Approved)
- Parcel 50 Barnes & Noble Tenant Signage (Approved)
- Parcel 50 Crumbl Cookies Awning and Tenant Signage (Approved)
- Parcel 95 Coco Beach Bar and Grill Tenant Signage (Approved)
- Parcel 102 Marina 41 Apartments Exterior Improvements (Approved)
- Parcel BB Loyola Marymount Boathouse Exterior Improvements and Tenant Signage (Approved)

- Parcel BR Aubrey Austin Park Renovation Final Design (Approved)
- Parcels HS & 91 Marina “Mother’s” Beach Renovation Conceptual Design (Approved)

#### Future Projects

DBH is working on a new “Signage and Gateways Master Plan” for Marina del Rey. The purpose of the plan is to update and replace the existing gateway, wayfinding, and informational signage throughout Marina del Rey in order to (a) create an identity and sense of place for the Marina, (b) enhance the experience of Marina del Rey visitors by making the community more easily navigable, and (c) create awareness of and highlight water-oriented activities and community features, consistent with the urgent community needs and priorities identified through the Marina del Rey for All initiative.

A conceptual plan for this project was approved by DCB in December 2017. DBH is working with a consultant to develop revised conceptual designs for the project, which will be presented to DCB for review and approval in the near future.